



GOVERNMENT OF BERMUDA Ministry of Public Works

Department of Public Lands and Buildings

P.O. Box HM51364 Hamilton HMFX Bermuda Phone: (441) 295-5151 Fax: (441) 295-5658

GENERAL NOTES:

- 1. SURVEY GRID IS BNG2000 IMPERIAL.
- 2. LEVELS ARE IN FEET ABOVE ORDNANCE DATUM. 3. CONTOUR DATA FROM 2020 LIDAR.
- DETAIL NEAR HORTICULTURAL HALL ADOPTED FROM 48320103 DWG.
- 5. ALL OTHER TOPOGRAPHIC DETAIL FROM 2012 TMD.
- 6. SLAT HOUSE INTERIOR AND EASTERN ENTRANCE FROM LASER SCAN POINT CLOUD.



THIS PLAN MUST NOT BE ALTERED IN ANY WAY UNLESS AUTHORISED BY THE SENIOR LAND SURVEYOR ONLY AUTHENTICATED COPIES OF THIS PLAN SHOULD BE USED © COPYRIGHT – BERMUDA GOVERNMENT

ISSUED FOR: AMENDMENTS: NO: REVISION APP DATE: SCALE: 1"= 20' SURVEY PREPARED BY: DATE: DESIGN DATE: PREPARED BY: CHECKED BY: DATE: DRAWING PREPARED BY: 04/07/24 DATE: 04/07/24 CD CHECKED BY: SP APPROVED BY: S. PATTERSON – SENIOR LAND SURVEYOR PROJECT NUMBER: 30/243/14 TASK 240028 PROJECT NAME: EXOTIC AND

CACTUS HOUSE TOPO BOTANICAL GARDENS SOUTH ROAD PAGET

DRAWING FILE NO: CIVIL 3D 2019 PIMS\SURVEYPROJECTS\3024314\483201005 SHEET TITLE:

REVISION

 \bigwedge

TOPOGRAPHIC SURVEY

4832/010/05





GENERAL NOTES:

- 1. ALL DRAWINGS SHALL BE READ IN CONJUNCTION WITH THE SPECIFICATION AND ANY OTHER WRITTEN INSTRUCTIONS ISSUED
- 2. WHERE APPROVAL IS REQUIRED. THIS SHALL BE OF THE DESIGNING ENGINEER AND/OR REPRESENTATIVE.
- 3. ANY AMBIGUITY OR DISCREPANCY SHALL BE REFERRED FOR CLARIFICATION AT THE TENDERING STAGE AND APPROVAL GAINED FROM THE DESIGNING ENGINEER/REPRESENTATIVE
- DIMENSIONS ARE IN PRESENTED MILLIMETERS WITH EQUIVALENT FOOT/INCH VALUE SHOWN IN BRACKETS.
- EXAMPLE: 1000mm [3'-3 a'']
- 3. REFER TO THE DRAWING DIMENSIONS FOR SETTING OUT THE WORKS. HOWEVER, ALL EXISTING DIMENSIONS AND LEVELS ARE APPROXIMATE AND SHALL BE CONFIRMED BY THE CONTRACTOR ON SITE. 4. UNLESS NOTED OTHERWISE, ALL LEVELS ARE IN METRES [m]
- 5. THE CONTRACTOR SHALL BE RESPONSIBLE FOR MAINTAINING THE STABILITY OF THE STRUCTURE UNTIL ITS COMPLETION AND SHALL ENSURE THAT NO PART OF THE STRUCTURE IS OVERSTRESSED DURING THE WORKS.
- 6. WHERE STANDARDS ARE REFERRED TO, THEY SHALL BE THE LATEST EDITION.
- 7. PROPRIETARY ITEMS, PROPOSED BY THE CONTRACTOR, ARE TO BE APPROVED EQUALS, REVIEWED AND APPROVED BY THE DESIGNING ENGINEER PRIOR AND INCLUDED WITHIN SUBMITTED TENDERS. THE CONTRACTOR SHALL BE RESPONSIBLE FOR SECURING WORK AREAS
- ALL DEMOLITION SHALL BE IN AN ACCEPTABLE MANNER UNDER THE OCCUPATIONAL HEALTH AND SAFETY REGULATIONS 2009. ALL SURPLUS MATERIAL SHALL BE DISPOSED OF OFF SITE IN A LEGAL MANNER.

SITE PROTECTION NOTES

- UNLESS NOTED OTHERWISE.
- HAND OR AIR EXCAVATION TOOLS.

3.3.

3.4.

COMPACTION, SETTLEMENT, LATERAL MOVEMENT, UNDERMINING, EROSION, WASH OUT AND OTHER HAZARDS CREATED BY CONSTRUCTION ACTIVITY.

TIMBER NOTES: 1. THE TIMBER STRUCTURE HAS BEEN DESIGNED WITH PINE WOOD TO A MINIMUM GRADE No. 2. THE CONTRACTOR IS TO SUPPLY AND INSTALL SPECIFIED TIMBER 2. IF SPECIFIED TIMBER IS NOT AVAILABLE OR AN ALTERNATIVE WOOD IS PREFERRED, THE DESIGNING ENGINEER IS TO BE CONSULTED PRIOR TO PURCHASING, SUPPLY AND INSTALLATION. 3. 14 GAUGE WOOD SCREWS (6.2mm DIAMETER) ARE TO BE USED THROUGHOUT FOR WOOD ON WOOD CONNECTIONS. **ROOFING NOTES:** 4. TIMBER IS TO BE TREATED AND PROTECTED FOR OUTDOORS CONDITIONS. 5. PARKS DEPARTMENT TO BE CONSULTED ON CHOSEN PAINTING SPECIFICATIONS DESIGN NOTES: DURING THE TENDERING PERIOD. 1. THE DESIGN OF THE TIMBER STRUCTURE AS SHOWN IN THIS PACKAGE OF DRAWINGS IS BASED ON THE FOLLOWING PARAMETERS: THE ROOF. LOADING $= 0.1 \text{ kN/m}^2$ (2.1 lbs/ft²) PERMANENT ROOF LOADING 3.1. 3.2.

 $= 0.25 \text{ kN/m}^2 (5.2 \text{ lbs/ft}^2)$ SERVICE LOADING * (*HANGING SERVICES SUCH AS CABLING AND MECHANICAL EQUIPMENT)

 $= 0.6 \text{ kN/m}^2 (12.5 \text{ lbs/ft}^2)$

1. THE CONTRACTOR SHALL INSTALL SITE PROTECTION AS APPROVED BY THE PROJECT MANAGER PRIOR TO THE START OF CLEARING, DEMOLITION, GRADING OR OTHER CONSTRUCTION WORK.

2. THE CONTRACTOR SHALL VERIFY LOCATION OF ALL BURIED SERVICES WITH THE RELEVANT AUTHORITIES BEFORE UNDERTAKING EXCAVATION WORK ON SITE. ALL EXISTING PLANTS, SERVICES AND WALKWAY FINISHES ARE TO REMAIN

3. THE CONTRACTOR SHALL PROTECT ALL EXISTING TREES, PLANTS AND PLANTING BED SURFACES FROM CONSTRUCTION ACTIVITY. THIS INCLUDES PROTECTION FROM DAMAGE CAUSED BY RUNOFF OR SPILLAGE OF CONSTRUCTION MATERIALS. AND OR FROM ADJACENT CONSTRUCTION ACTIVITIES.

4. ALL DEMOLITION AND EXCAVATION WITHIN TREE DRIP LINES AND SITE PROTECTION AREAS SHALL BE ACCOMPLISHED BY

THE CONTRACTOR SHALL PROTECT TREE AND PLANT ROOT SYSTEMS FROM DAMAGE CAUSED BY RUNOFF OR SPILLAGE OF CONSTRUCTION MATERIALS AS WELL AS FROM CONSTRUCTION ACTIVITIES.

THE CONTRACTOR SHALL PROTECT TREE AND PLANT ROOT SYSTEMS FROM FLOODING, ERODING, OR EXCESSIVE WETTING CAUSED BY CONSTRUCTION ACTIVITIES.

THE CONTRACTOR SHALL NOT DISTURB, OPERATE VEHICLES OR EQUIPMENT, STORE MATERIALS, OR PERMIT FOOT TRAFFIC WITHIN TREE PROTECTION AND PLANT BED AREAS.

THE CONTRACTOR SHALL KEEP PLANT BEDS AND TREE PROTECTION AREAS FREE FROM LITTER AND DEBRIS.

THE CONTRACTOR SHALL FIELD VERIFY ALL POST LOCATIONS AND PROMPTLY NOTIFY THE PROJECT MANAGER OF ANY DISCREPANCIES OR CONSTRUCTION CONFLICTS WITH EXISTING PLANTS, ROOT SYSTEMS OR PLANT PROTECTION AREAS PRIOR TO START OF CONSTRUCTION WORK. OBTAIN WRITTEN INSTRUCTION FROM THE PROJECT MANAGER PRIOR TO PROCEEDING WITH ANY CONSTRUCTION ACTIVITY WITHIN PLANT PROTECTION AREAS.

10. THE CONTRACTOR SHALL PROTECT EXISTING GRASSES, SOILS AND EARTHWORK FROM DAMAGE CAUSED BY

SITE / PLANT DAMAGE & REPAIR NOTES:

- SHOULD EXISTING PLANTS BE DAMAGED DURING THE CONTRACT. THE CONTRACTOR WILL BE ASKED TO ARRANGE TO PRUNE, REPAIR OR REPLACE AS NECESSARY THOSE AFFECTED BY INADVERTENT ROOT LOSS OR DAMAGE.
- THE CONTRACTOR SHALL ARRANGE TO REPAIR PLANTS DAMAGED BY CONSTRUCTION OPERATIONS WITHIN 24 HOURS AS DIRECTED BY THE PROJECT MANAGER.
- THE CONTRACTOR SHALL REPLACE PLANTS DAMAGED BEYOND REPAIR AS DETERMINED BY THE PROJECT MANAGER WITH APPROVED EQUAL OR BETTER MATERIAL
- 4. THE CONTRACTOR SHALL REINSTATE ALL GRASS AREAS DAMAGED BY CONSTRUCTION ACTIVITY AND VEHICLES AS DIRECTED BY THE PROJECT MANAGER

CONCRETE NOTES:

- 1. CONCRETE SHALL COMPLY WITH THE FOLLOWING SPECIFICATION:
 - MINIMUM CONCRETE STRENGTH AT SERVICE F'c = 25 MPa [3600PSI]
- MINIMUM CEMENT CONTENT
- MAXIMUM WATER/CEMENT RATIO = 0.5

2. CONCRETE MIX DESIGNS TO BE SUBMITTED TO THE ENGINEER FOR APPROVAL 3. NO ADDITIVES TO BE USED WITHOUT THE PRIOR APPROVAL OF THE ENGINEER. 4. CAST IN ITEMS WITH LESS THAN 25mm COVER TO ATMOSPHERE SHALL BE HOT DIPPED GALVANISED IN

- ACCORDANCE WITH ASTM A153. 5. ALL FORMWORK, SHORING AND RESHORING SHALL BE THE RESPONSIBILITY OF AND DESIGNED BY THE
- CONTRACTOR
- DAY STRENGTHS.
- 5. CONCRETE STRENGTH AND SLUMP TO BE AS FOLLOWS

MIN. SPECIFIED 28 DAY STRENGTH S	
	28 DAY STRENGTH SL
	5 MPa 75mm
[3600PSI] [3	500PSI] [3"

ISOMETRIC VIEW OF NEW CACTI HOUSE 1/4'' = 1'-0''

ROOF PANELING HAS BEEN DESIGNED AS PHASE-2 PVC CORRUGATED ROOF PANELS 4.2" x 1-1/16" CONFIGURATION (16 Oz./ft²). IF ALTERNATIVE ROOF CLADDING IS TO BE USED, CORRESPONDING TECHNICAL SPECIFICATIONS ARE TO BE SENT TO MPW ENGINEER FOR REVIEW

THE ROOF STRUCTURE HAS BEEN DESIGNED TO ALLOW HUMAN ACCESS FOR MAINTENANCE AND CLEANING. ADEQUATE AT-HEIGHT-PROTECTION TO BE EMPLOYED BY PERSONNEL WORKING ON

UPPER HUT VERTICALS TO BE COVERED IN MESH TO MEET THE FOLLOWING SPECIFICATIONS: MESH DURABILITY: MARINE-GRADE (E.G. COATED, GALVANIZED OR PVC) MESH SIZE: SIZED TO PREVENT ACCESS BY SMALL BIRDS LIKE SPARROWS MESH OPENING SHAPE: DIAMOND, SQUARE OR RECTANGULAR SHAPES PERMITTED MESH COLOR: PROVIDE COLOR OPTIONS FOR CLIENT REVIEW AND SELECTION.

 $= 440 \text{ Kg/m}^3 [28 \text{ lb/ft}^3]$

4. CONCRETE SHALL BE TESTED FOR SLUMP ON SITE. THE TEST CYLINDERS SHALL BE TAKEN FOR 3, 7 AND 28


UMP ım ± 25mm 3" ± 1"]

~	600	1200	1800	2400	3000	3600	4200mm
	2'	4'	6'	8'	10'	12'	
			T ORIGIN				Ⅎ

THE MINISTRY OF PUBLIC WORKS P.O. Box HM525 Hamilton HMCX Bermuda Phone: (441) 295-5151

DEPARTMENT OF WORKS AND ENGINEERING

Fax: (441) 295-5658

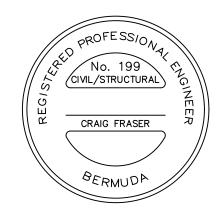

ISSUED FOR: BUILDING PERMIT APPLICATION

AMENDMENTS:

NO	REVISION	ΒY	APP	DATE
Α	FOR TENDER	CF	1	14/06/24
В	REVISED FOLLOWING DESIGN TEAM COMMENTS	CF	Ι	04/07/24
С	REVISED FOLLOWING DESIGN TEAM COMMENTS	CF	-	11/07/24
D	ISSUED FOR BUILDING PERMIT APPLICATION	CF	I	12/07/24
E	SCALES CHANGED AT REQUEST OF QS	CF	Ι	12/08/24

SCALE: AS SHOWN AT ANSI D

SURVEY

DATE:
DATE: 14/06/24
DATE: —
DATE: 14/06/24
DATE: —
DATE: —

PROJECT NUMBER:

PROJECT NAME: BOTANICAL GARDENS CACTI HOUSE REFURBISHMENTS 2024

COPY FOR ESTIMATING

GENERAL NOTES

SHEET TITLE:


SHEET NUMBER:

S000


PROPOSED DESIGN

E

REVISION

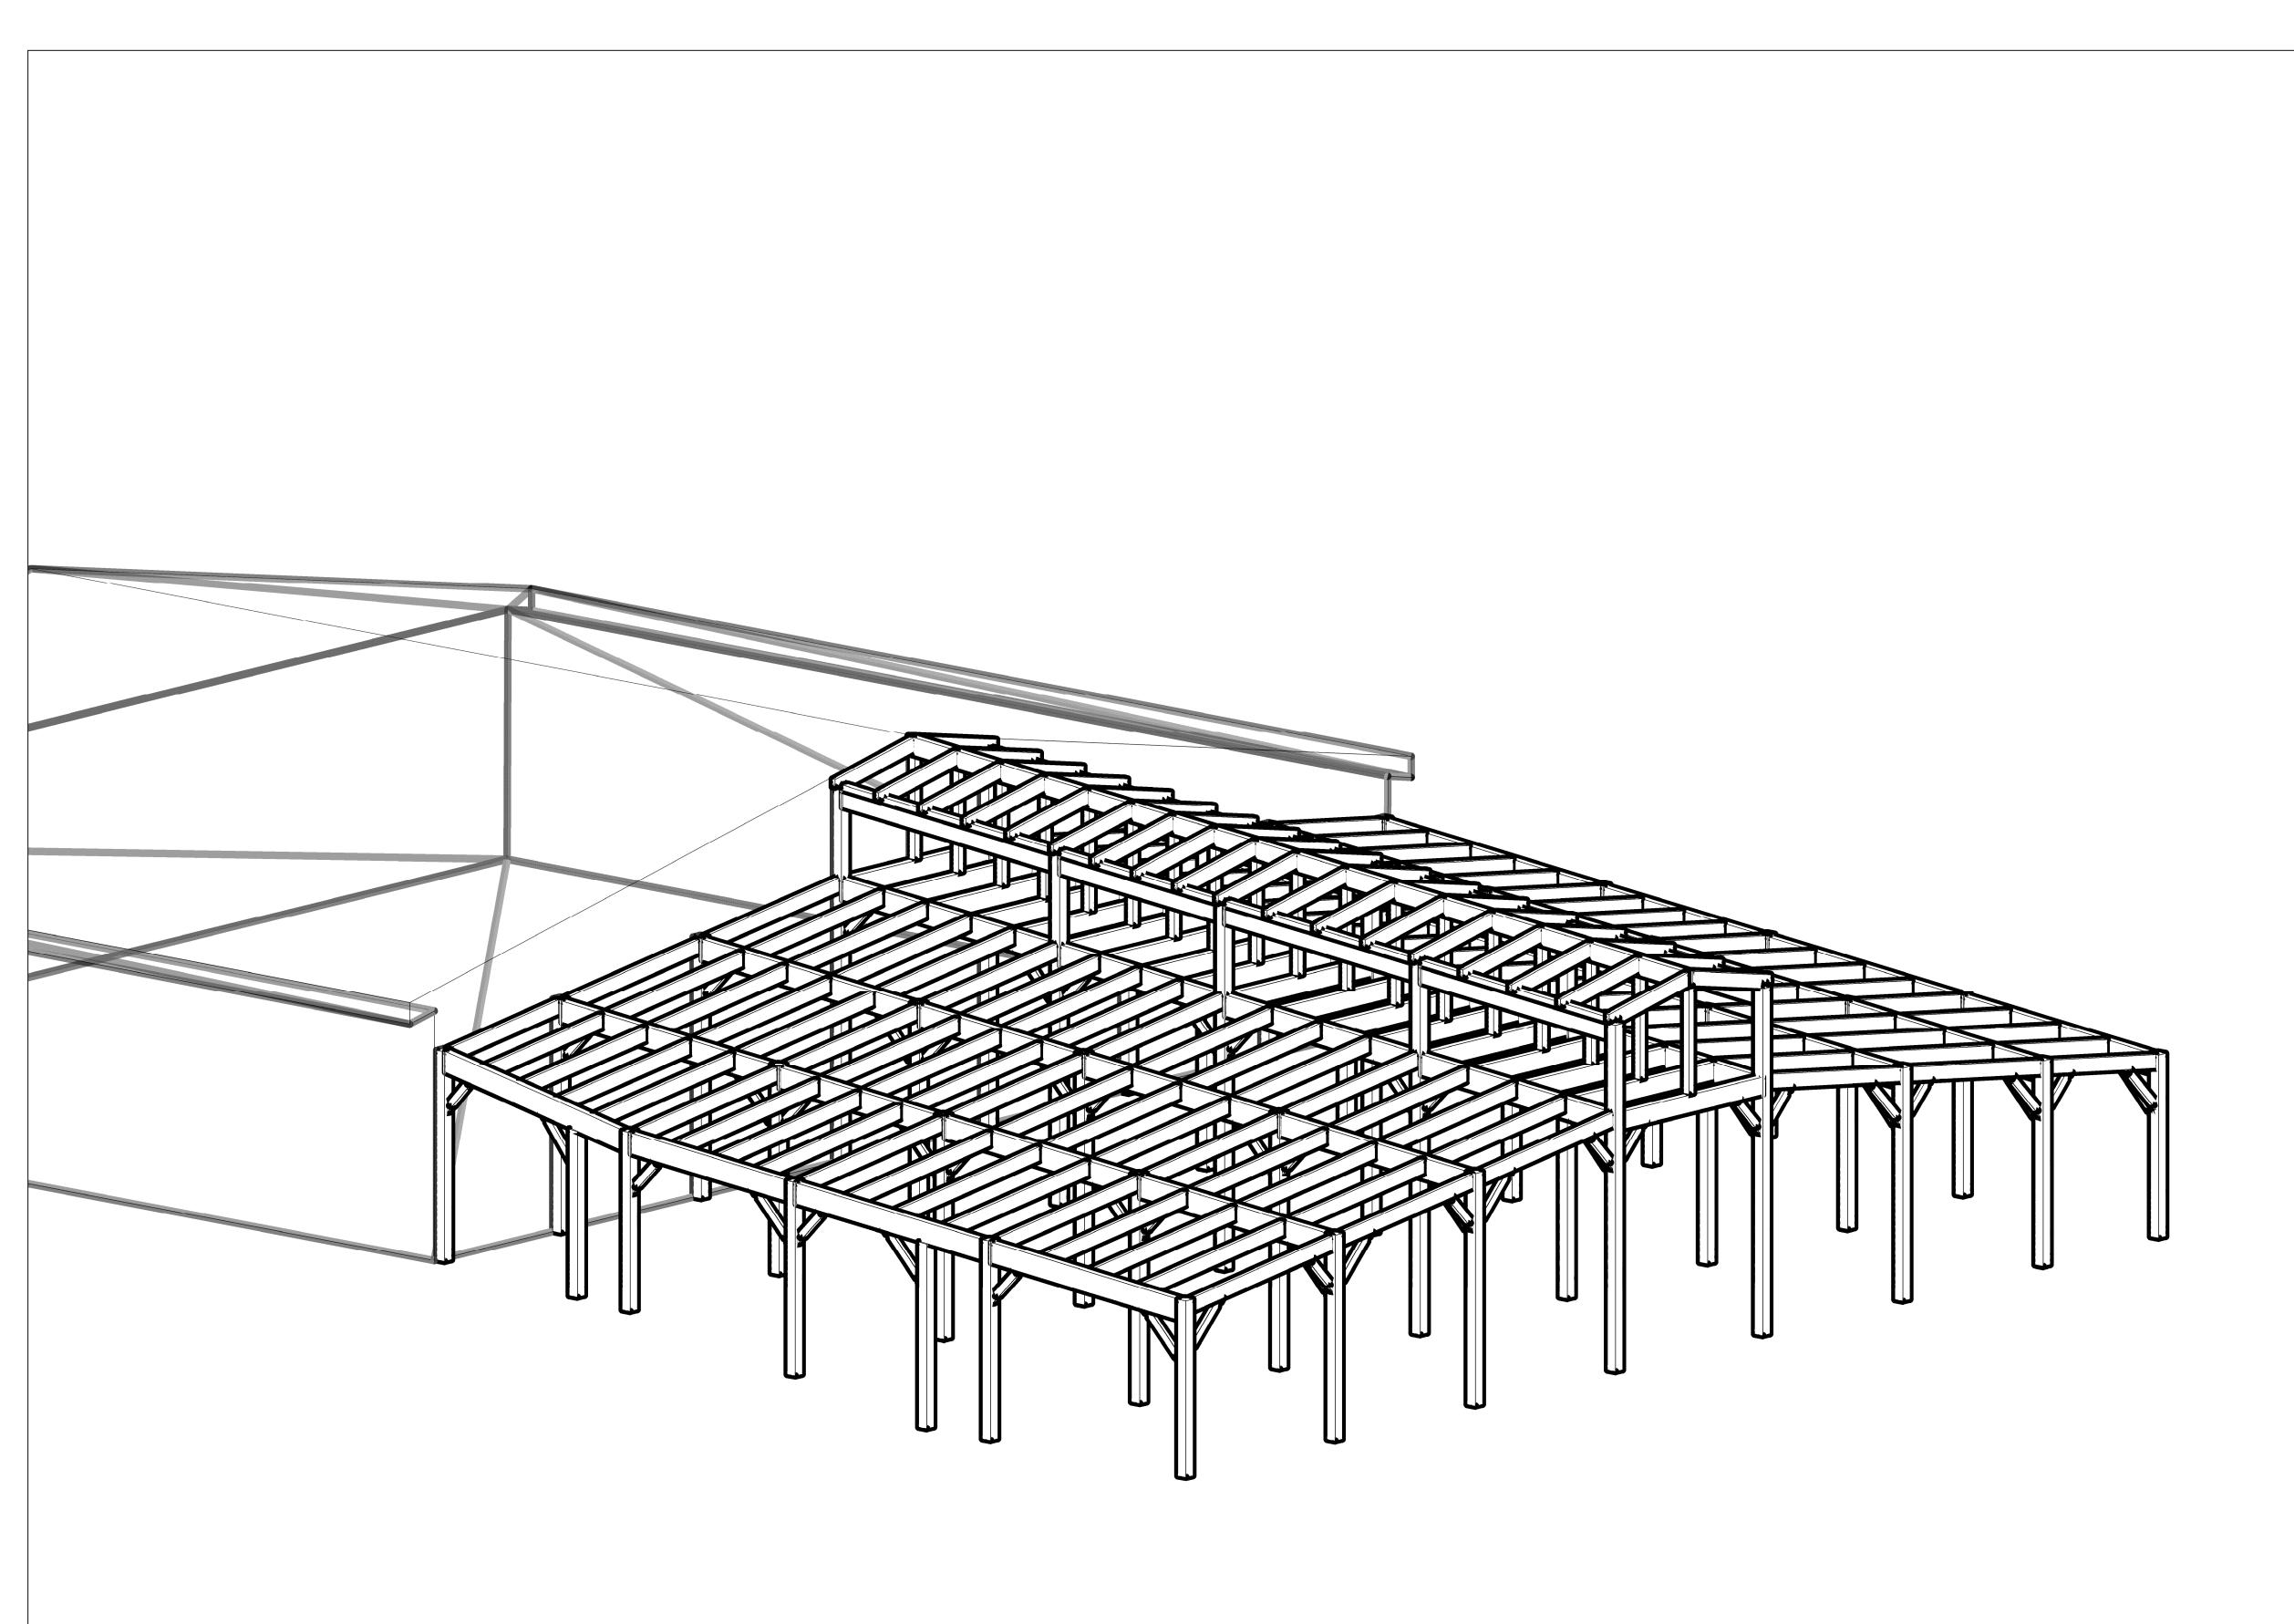

<u>ISOMETRIC VIEW OF NEW CACTI HOUSE</u> <u>TIMBER STRUCTURE ONLY</u> <u>ROOF PANELS, PURLINS AND SIDE FENCING HIDDEN FOR CLARITY</u> 1/4" = 1'-0"

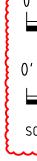

	600	1200	1800	2400	3000	3600	4200mm
	2'	1.'	6'	8'	10'	12'	
		4					4
AL	E 1/4" =	= 1'-0" A ⁻	r origin,	AL SIZE			

SHEET	NUMBER:
S00	1

REVISION

D

3D VIEW PROPOSED DESIGN

SHEET TITLE:

COPY FOR ESTIMATING

2024

BOTANICAL GARDENS CACTI HOUSE REFURBISHMENTS

PROJECT NAME:

—

PROJECT NUMBER:

C.FRASER	14/06/24
CHECKED BY:	DATE:
_	_
DRAWING	
PREPARED BY: C.FRASER	DATE: 14/06/24
CHECKED BY: -	DATE:
APPROVED BY:	DATE: —

PREPARED BY: _	DATE: _
DESIGN	
PREPARED BY: C.FRASER	DATE: 14/06/2-
CHECKED BY:	DATE:
_	—

SCALE: AS SHOWN AT ANSI D

AMENDMENTS:

SURVEY

١	10	REVISION	ΒY	APP	DATE
	А	FOR TENDER	CF	_	14/06/24
	В	REVISED FOLLOWING DESIGN TEAM COMMENTS	CF	-	04/07/24
_	С	ISSUED FOR BUILDING PERMIT APPLICATION	CF	-	12/07/24
	D	SCALES CHANGED AT REQUEST OF QS	CF		12/08/24
_					


ISSUED FOR: BUILDING PERMIT APPLICATION



Fax: (441) 295-5658

DEPARTMENT OF WORKS AND ENGINEERING

THE MINISTRY OF PUBLIC WORKS P.O. Box HM525 Hamilton HMCX Bermuda Phone: (441) 295-5151

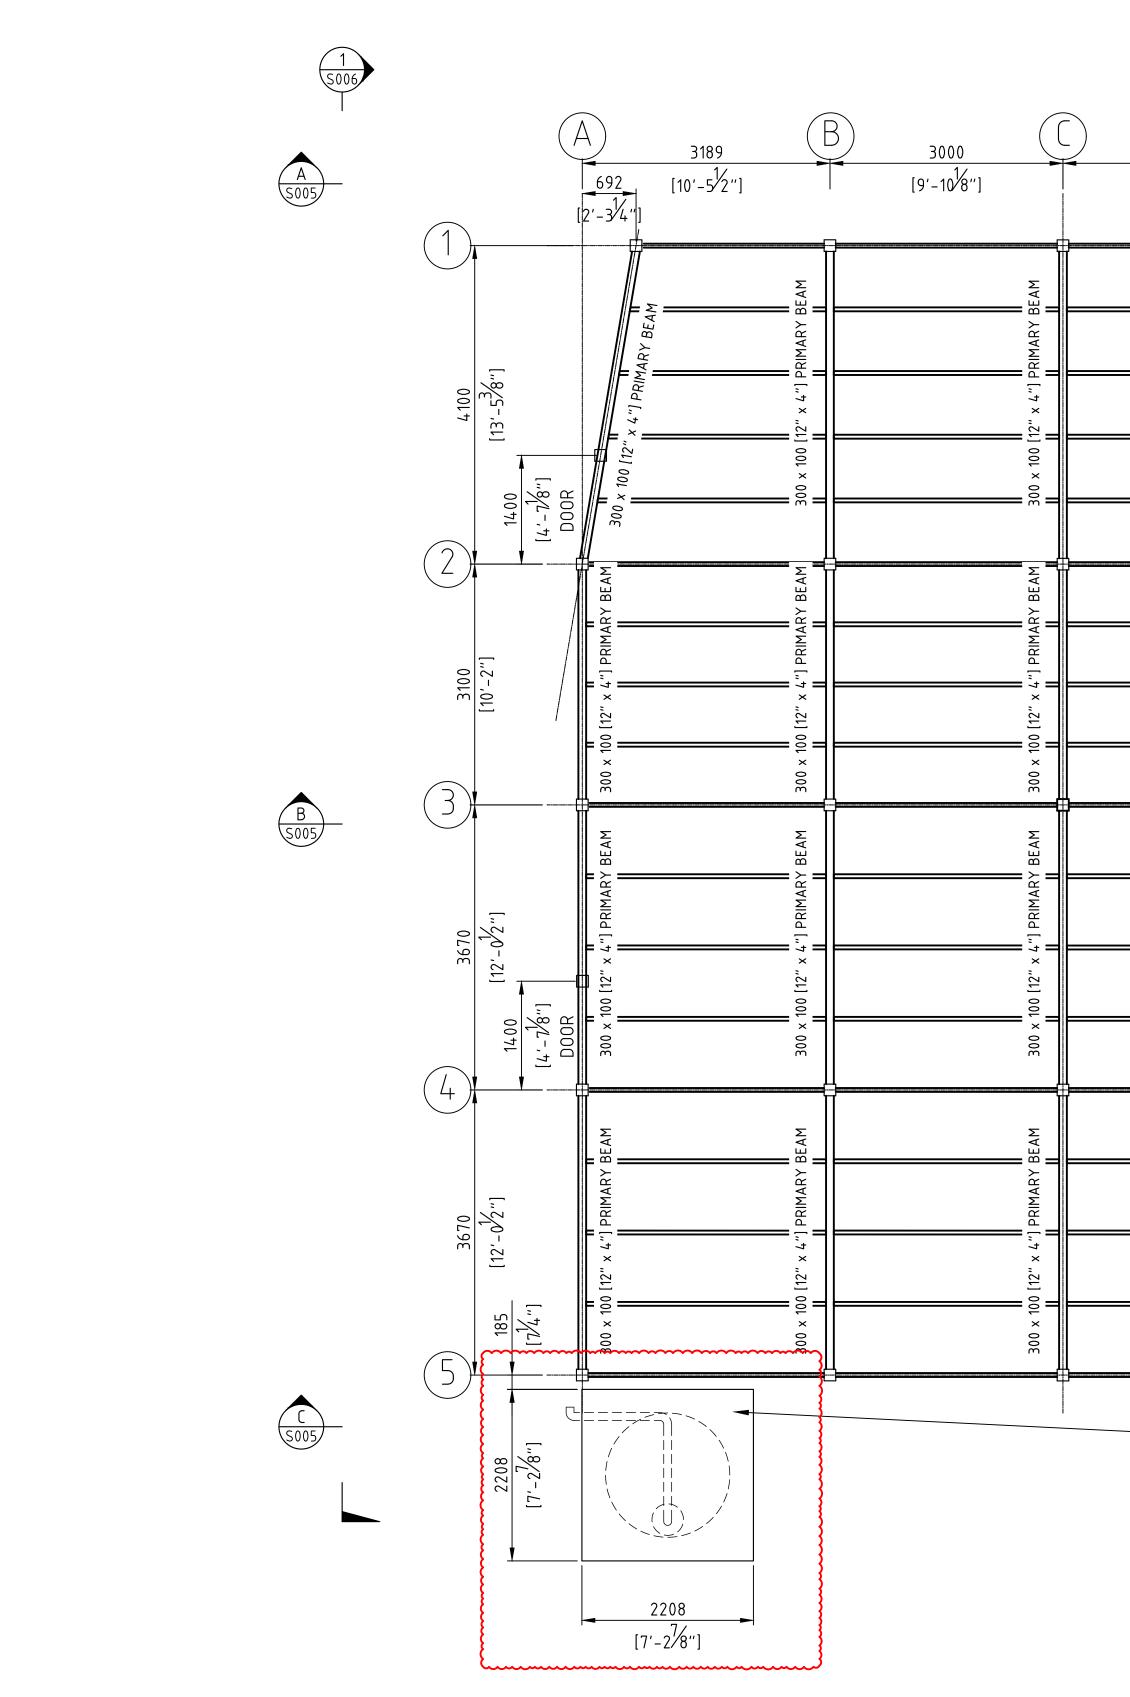


<u>3000</u> [9'-10 ¹ 8'']	D 3150 [10'-4"] DOOR TO JJ OUTERB BUILDING	E 30 [9'-10 RIDGE	> <	3000 [9'-10 ¹ 8'']		2497 [8'-2 ¹ /4'']	
x 4"] PRIMARY BEAM	× 4"] RIDGE BE	x 4"] PRIMARY BEAM	x 4"] PRIMARY BEAM		x 4"] PRIMARY BEAM	x 4"] PRIMARY BEAM	0 820 4 "[[2'-8 ¹ 4"]
300 × 100 [12"	250 × 100 [10"	M 300 × 100 [12"	M 300 × 100 [12"		M 300 × 100 [12"	1400 [,16"] B00R 300 ×	820 820 820 820 2'-8 ¹ 4" [[2'-8 ¹ 4" [[2'-8 ¹ 4
100 [12" × 4"] PRIMARY BEAM	100 [10" × 4"] RIDGE BEAM	100 [12" × 4"] PRIMARY BEAM) [12" × 4"] PRIMARY BEAM) [12" × 4"] PRIMARY BEAM	100 [12" × 4"] PRIMARY BEAM	75 775 820 6 ⁷ 2"12'-6 ⁷ 2"12'-8 ⁷ 4"]]
BEAM 300 × 100	BEAM 250 x 1	BEAM 300 × 100	BEAM 300 × 100 [12"		BEAM 300 × 100 [12'	BEAM 300 x	18 77518 775 7 0 ¹ 8'12[36 ¹ 0 ¹ 82]-6 ¹ 2'-12'-
300 x 100 [12" x 4"] PRIMARY	250 × 100 [10" × 4"] RIDGE	300 × 100 [12" × 4"] PRIMARY	300 x 100 [12" x 4"] PRIMARY		300 x 100 [12" x 4"] PRIMARY	14.00 [/ · -7]%"] DOOR 300 × 100 [12" × 4"] PRIMARY	916 918 918 918 918 918 918 3'-0 ¹ 8''] [3'-0 ¹ 8''] [3'-0 ¹ 8'']
100 [12" × 4"] PRIMARY	250 × 100 [10" × 4"] RIDGE BEAM	<pre>< 100 [12" × 4"] PRIMARY BEAM</pre>	<pre>< 100 [12" × 4"] PRIMARY BEAM</pre>		< 100 [12" × 4"] PRIMARY BEAM	< 100 [12" × 4"] PRIMARY BEAM	918 918 918 918 918 918 918 918 918 918
R	STRUCTURAL SUPPORT S RAINWATER HARVESTING AND PUMP ROOM REFER TO SHEET S011 FO	i TANKS	× 00E	2208	[7'-2/8"] 800 ×		
	NEW CACTIHOUS ANELS OMITTED F				L	2031 [6'-8'']	1891 [6'-2 ¹ 2'']


1/4'' = 1'-0''

ALE	1/4"	=	1'-0''	ΑT	ORIGINAL	SIZE

2'	<u></u> <u></u>	6'	8'	10'	12'
2	т	0	0	10	12

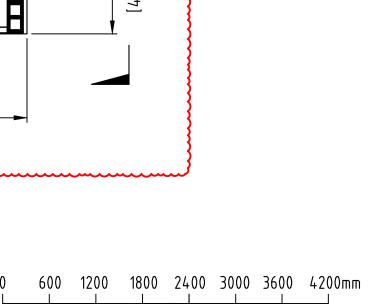

1250 [4'-1⁄4"]

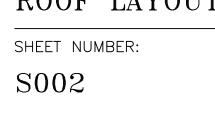

 \mathbf{F}

SHEET TITLE: GENERAL ARRANGEMENT ROOF LAYOUT

COPY FOR ESTIMATING

PROJECT NAME: BOTANICAL GARDENS CACTI HOUSE REFURBISHMENTS 2024

_

— PROJECT NUMBER:

C.FRASER	14/06/24
CHECKED BY:	DATE:
_	_
DRAWING	
PREPARED BY: C.FRASER	DATE: 14/06/24
CHECKED BY:	DATE:
_	_
APPROVED BY:	DATE:

DATE:

DATE:

_

_

PREPARED BY: _

SURVEY

PREPARED BY:

DESIGN

SCALE: AS SHOWN AT ANSI D

NO	REVISION	ΒY	APP	DATE
Α	FOR TENDER	CF	_	14/06/24
В	REVISED FOLLOWING DESIGN TEAM COMMENTS	CF	-	04/07/24
С	ISSUED FOR BUILDING PERMIT APPLICATION	CF	-	12/07/24
D	SCALES CHANGED AT REQUEST OF QS	CF	Ι	12/08/24
E	TANK SLABS ADDED	CF	-	30/08/24
F	TANK SLABS ADJUSTED	CF	-	25/03/25

AMENDMENTS:

ISSUED FOR: BUILDING PERMIT APPLICATION



Fax: (441) 295-5658

P.O. Box HM525 Hamilton HMCX Bermuda Phone: (441) 295-5151


THE MINISTRY OF

PUBLIC WORKS

DEPARTMENT OF

WORKS AND ENGINEERING

2 5006

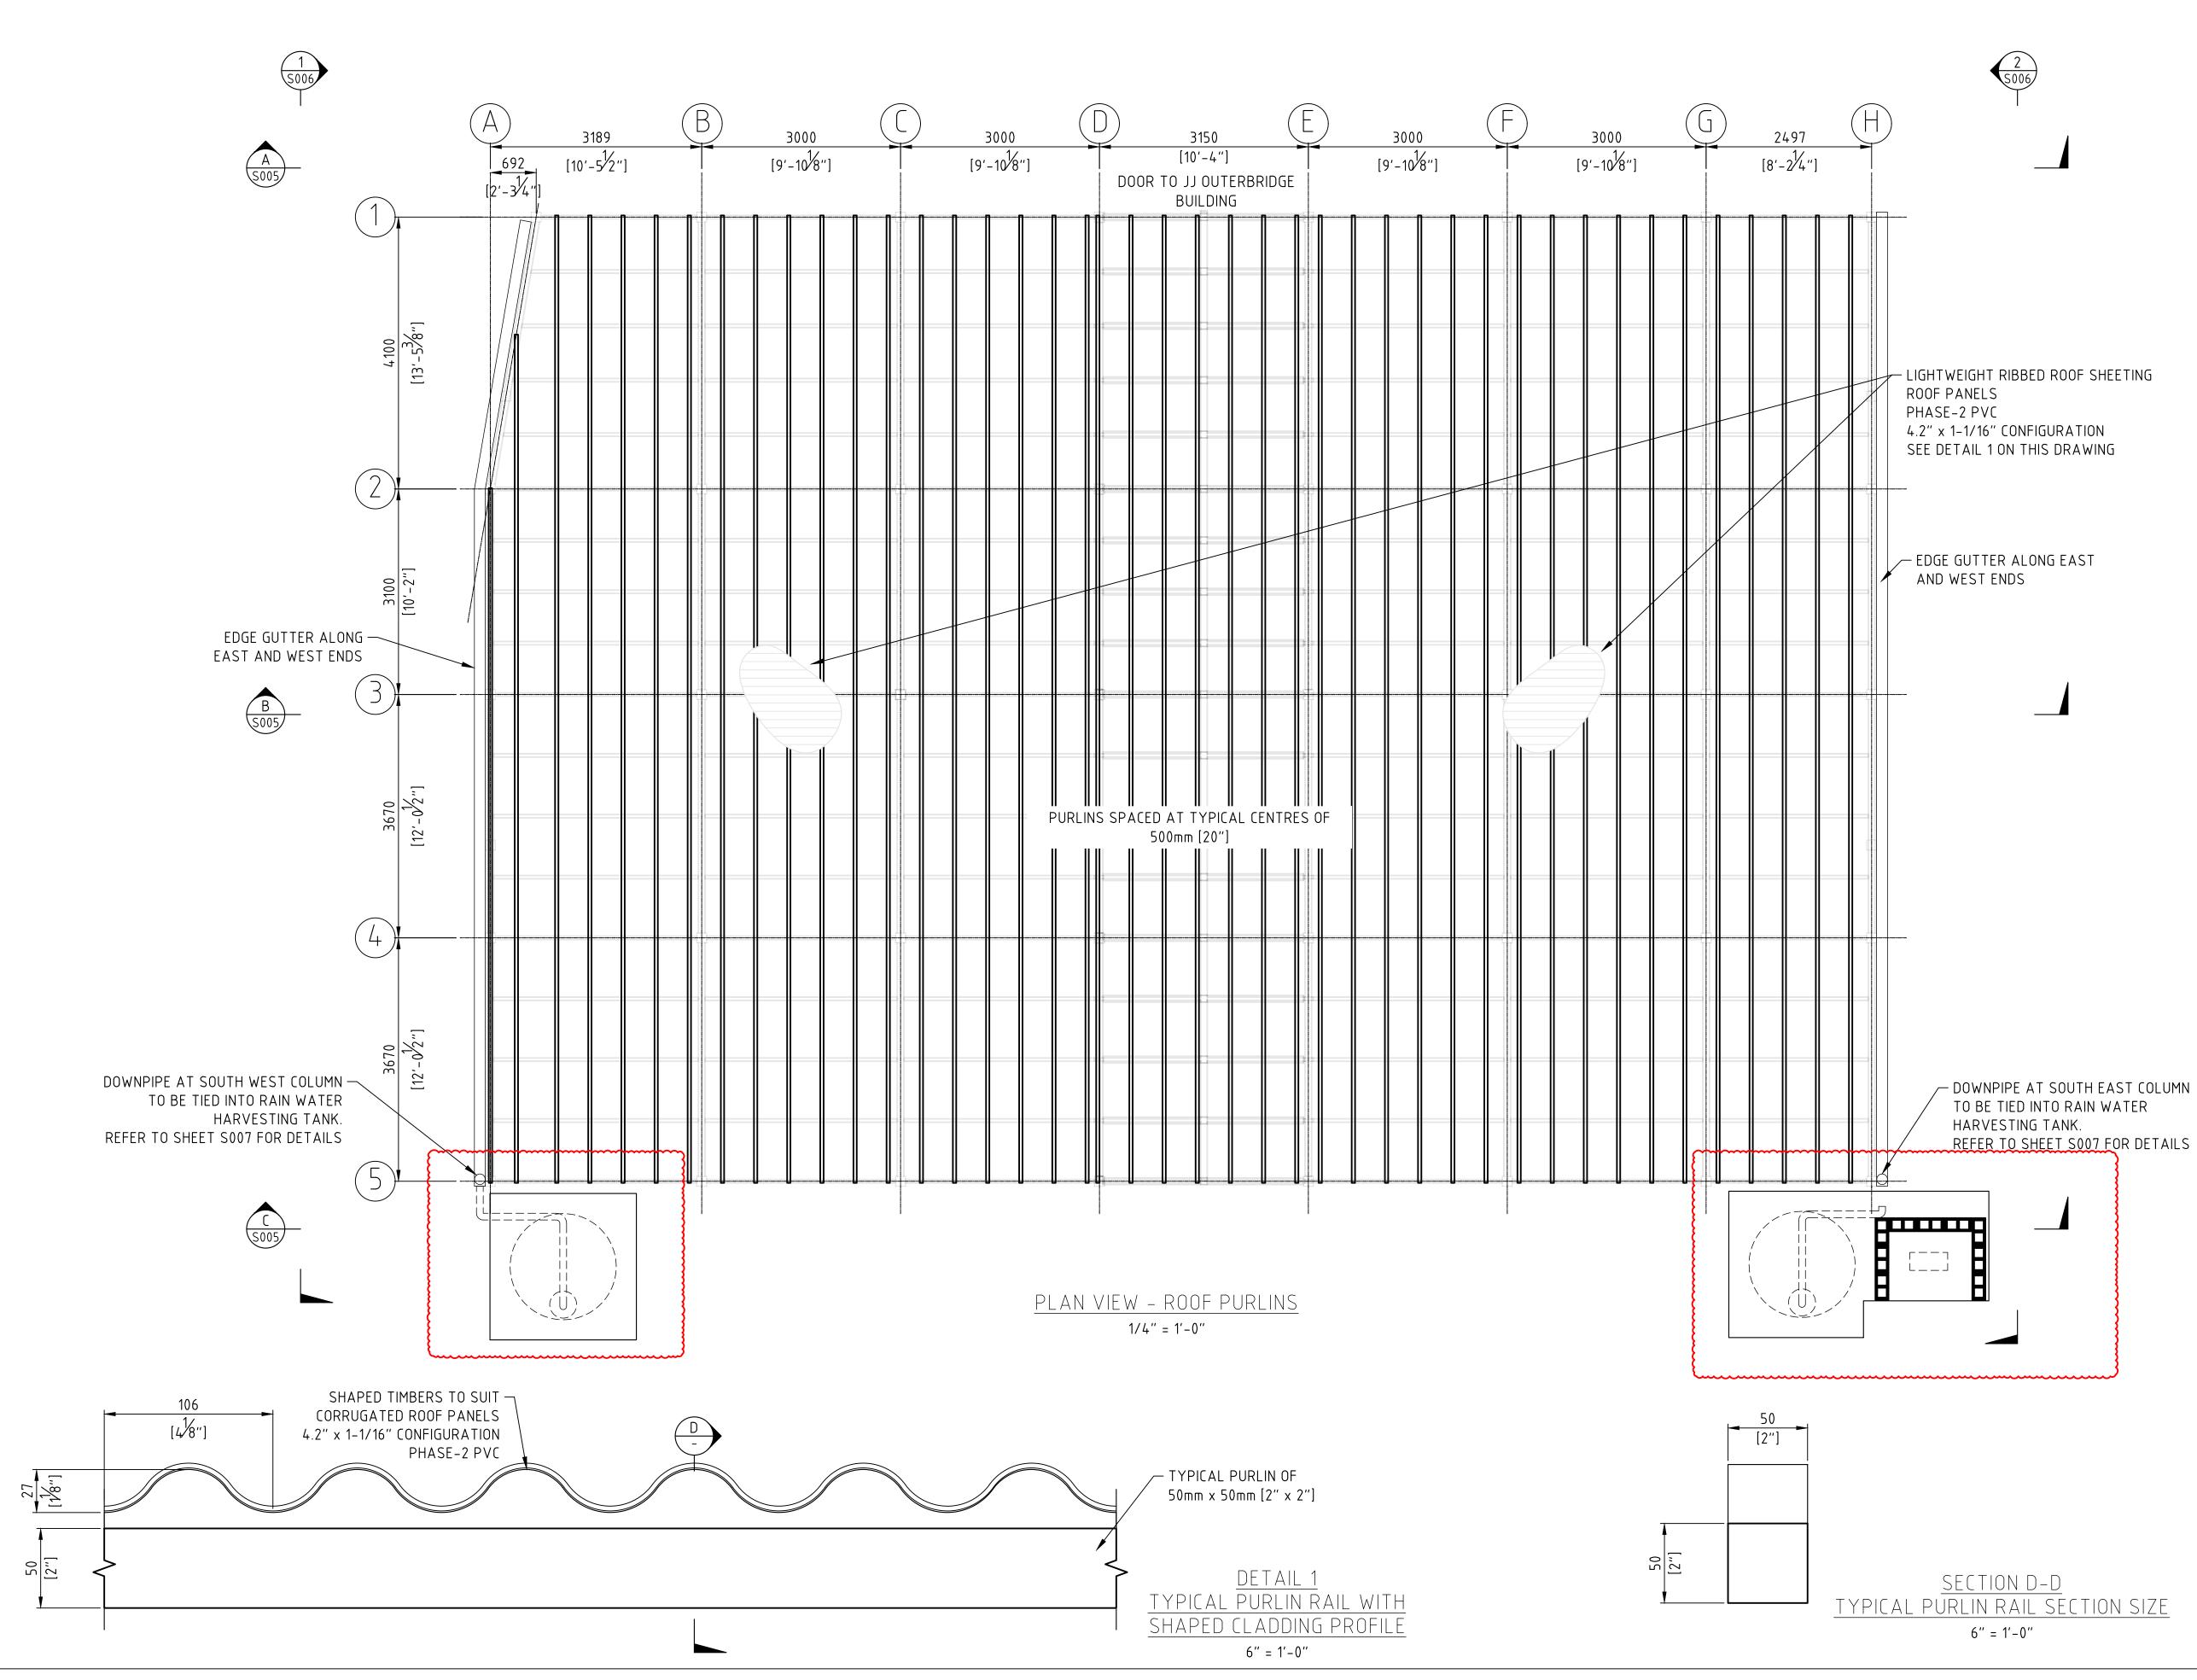

S003

REVISION

 \mathbf{F}

SHEET NUMBER:

GENERAL ARRANGEMENT ROOF PURLIN LAYOUT

SHEET TITLE:

COPY FOR ESTIMATING

2024

PROJECT NAME: BOTANICAL GARDENS CACTI HOUSE REFURBISHMENTS

PROJECT NUMBER: _

DATE: CHECKED BY: _ _ DRAWING DATE: 14/06/24 PREPARED BY: C.FRASER DATE: CHECKED BY: _ DATE: APPROVED BY: _ —

DATE: ____ DESIGN DATE: 14/06/24 PREPARED BY: C.FRASER

SURVEY PREPARED BY:

SCALE: AS SHOWN AT ANSI D

NO | REVISION | BY |APP| DATE A FOR TENDER CF - 14/06/24 B REVISED FOLLOWING DESIGN TEAM COMMENTS CF 04/07/24 ISSUED FOR BUILDING PERMIT APPLICATION CF 12/07/24 SCALES CHANGED AT REQUEST OF QS 12/08/24 l CF TANK SLABS ADDED CF 30/08/24 TANK SLABS ADJUSTED 25/03/25 L CF


AMENDMENTS:

ISSUED FOR: BUILDING PERMIT APPLICATION



DEPARTMENT OF WORKS AND ENGINEERING Fax: (441) 295-5658

THE MINISTRY OF PUBLIC WORKS P.O. Box HM525 Hamilton HMCX Bermuda Phone: (441) 295–5151

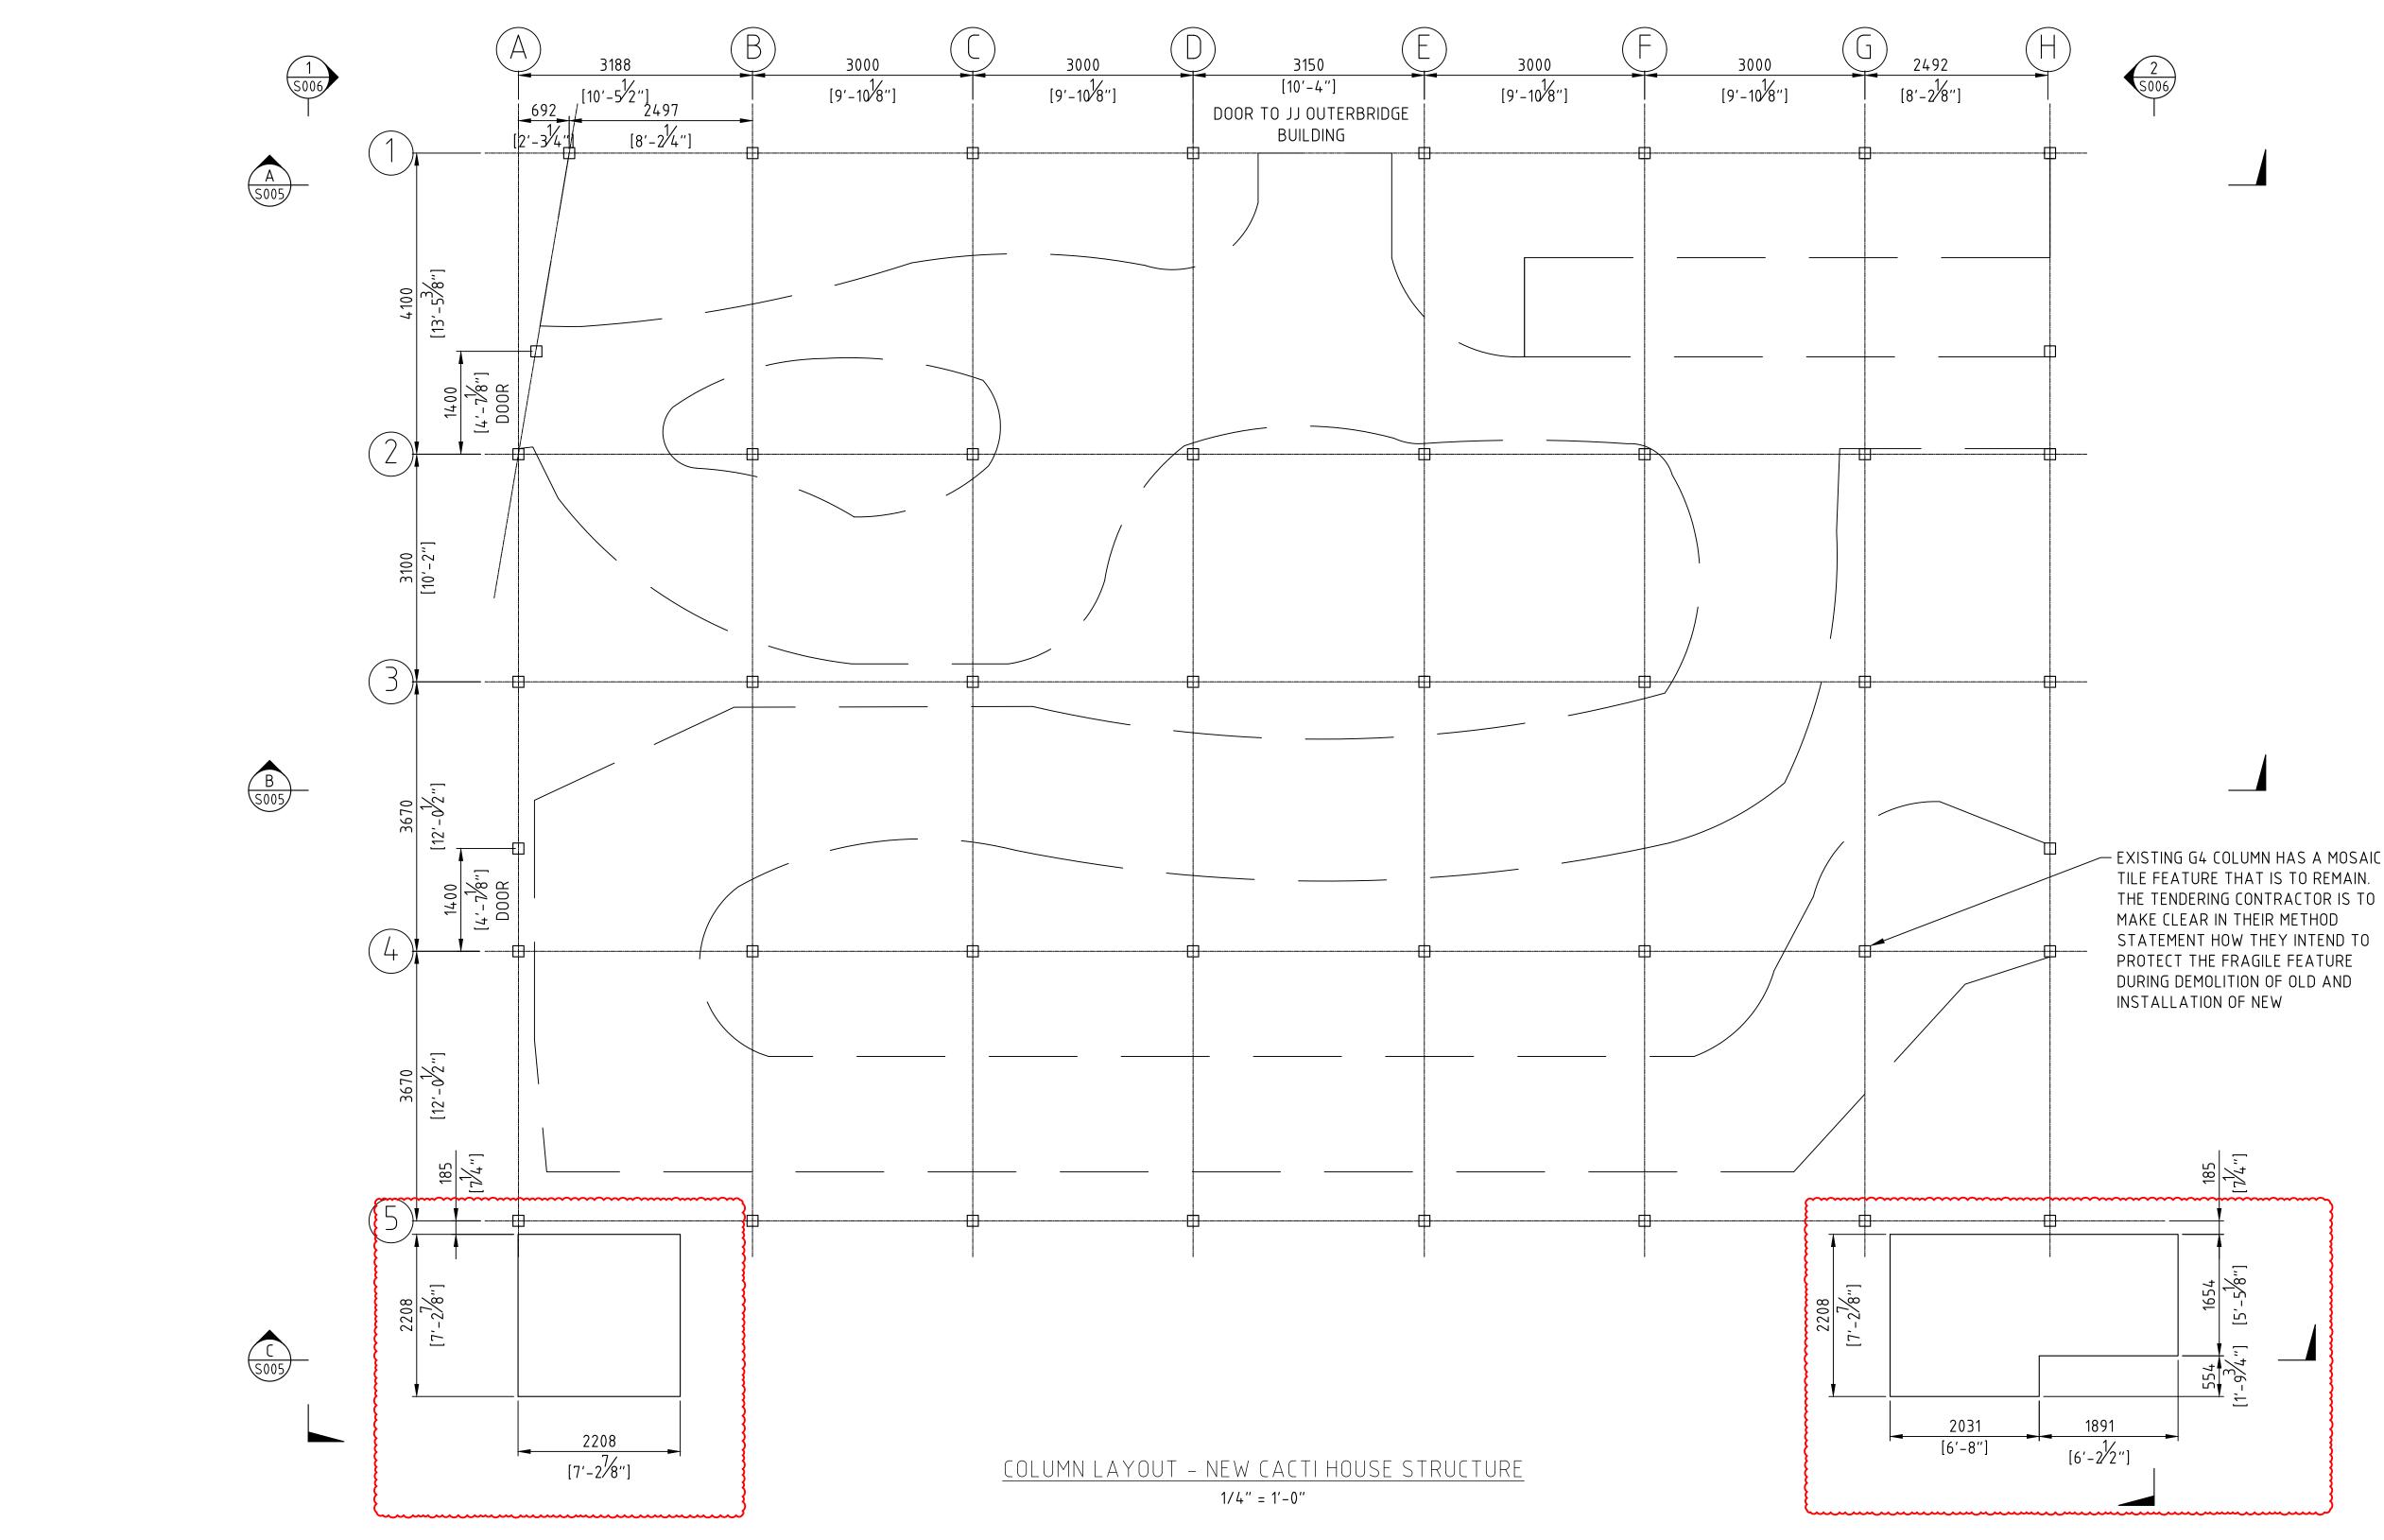

APPROXIMATE LAYOUT OF PLANTERS AND PATHWAYS SHOWN BY DASHED LINETYPE.

ALL TIMBER COLUMNS ARE TO BE 150mm x 150mm [6" X 6"] REFER TO SHEET S007 FOR FOUNDATION DETAILS

SCA

ALE	1/4″	=	1'-0"	ΑT	ORIGINAL	SIZE

0	600	1200	1800	2400	3000	3600	4200mm
0'	2'	4'	6'	8'	10'	12'	
							_

SHEET NUMBER: S004

REVISION

 \mathbf{F}

GENERAL ARRANGEMENT COLUMN LAYOUT

SHEET TITLE:

COPY FOR ESTIMATING

2024

PROJECT NAME: BOTANICAL GARDENS CACTI HOUSE REFURBISHMENTS

_

PROJECT NUMBER:

DRAWING DATE: 14/06/24 PREPARED BY: C.FRASER DATE: CHECKED BY: _ DATE: APPROVED BY: _ —

_ — DESIGN DATE: 14/06/24 PREPARED BY: C.FRASER DATE: CHECKED BY: — _

DATE:

SURVEY PREPARED BY:

SCALE: AS SHOWN AT ANSI D

NO	REVISION	ΒY	APP	DATE
Α	FOR TENDER	CF	_	14/06/24
В	REVISED FOLLOWING DESIGN TEAM COMMENTS	CF	-	04/07/24
С	ISSUED FOR BUILDING PERMIT APPLICATION	CF	-	12/07/24
D	SCALES CHANGED AT REQUEST OF QS	CF		12/08/24
E	TANK SLABS ADDED	CF	Ι	30/08/24
F	TANK SLABS ADJUSTED	CF	-	25/03/25

AMENDMENTS:

ISSUED FOR: BUILDING PERMIT APPLICATION




WORKS AND ENGINEERING Fax: (441) 295-5658

DEPARTMENT OF

PUBLIC WORKS P.O. Box HM525 Hamilton HMCX Bermuda Phone: (441) 295–5151

THE MINISTRY OF

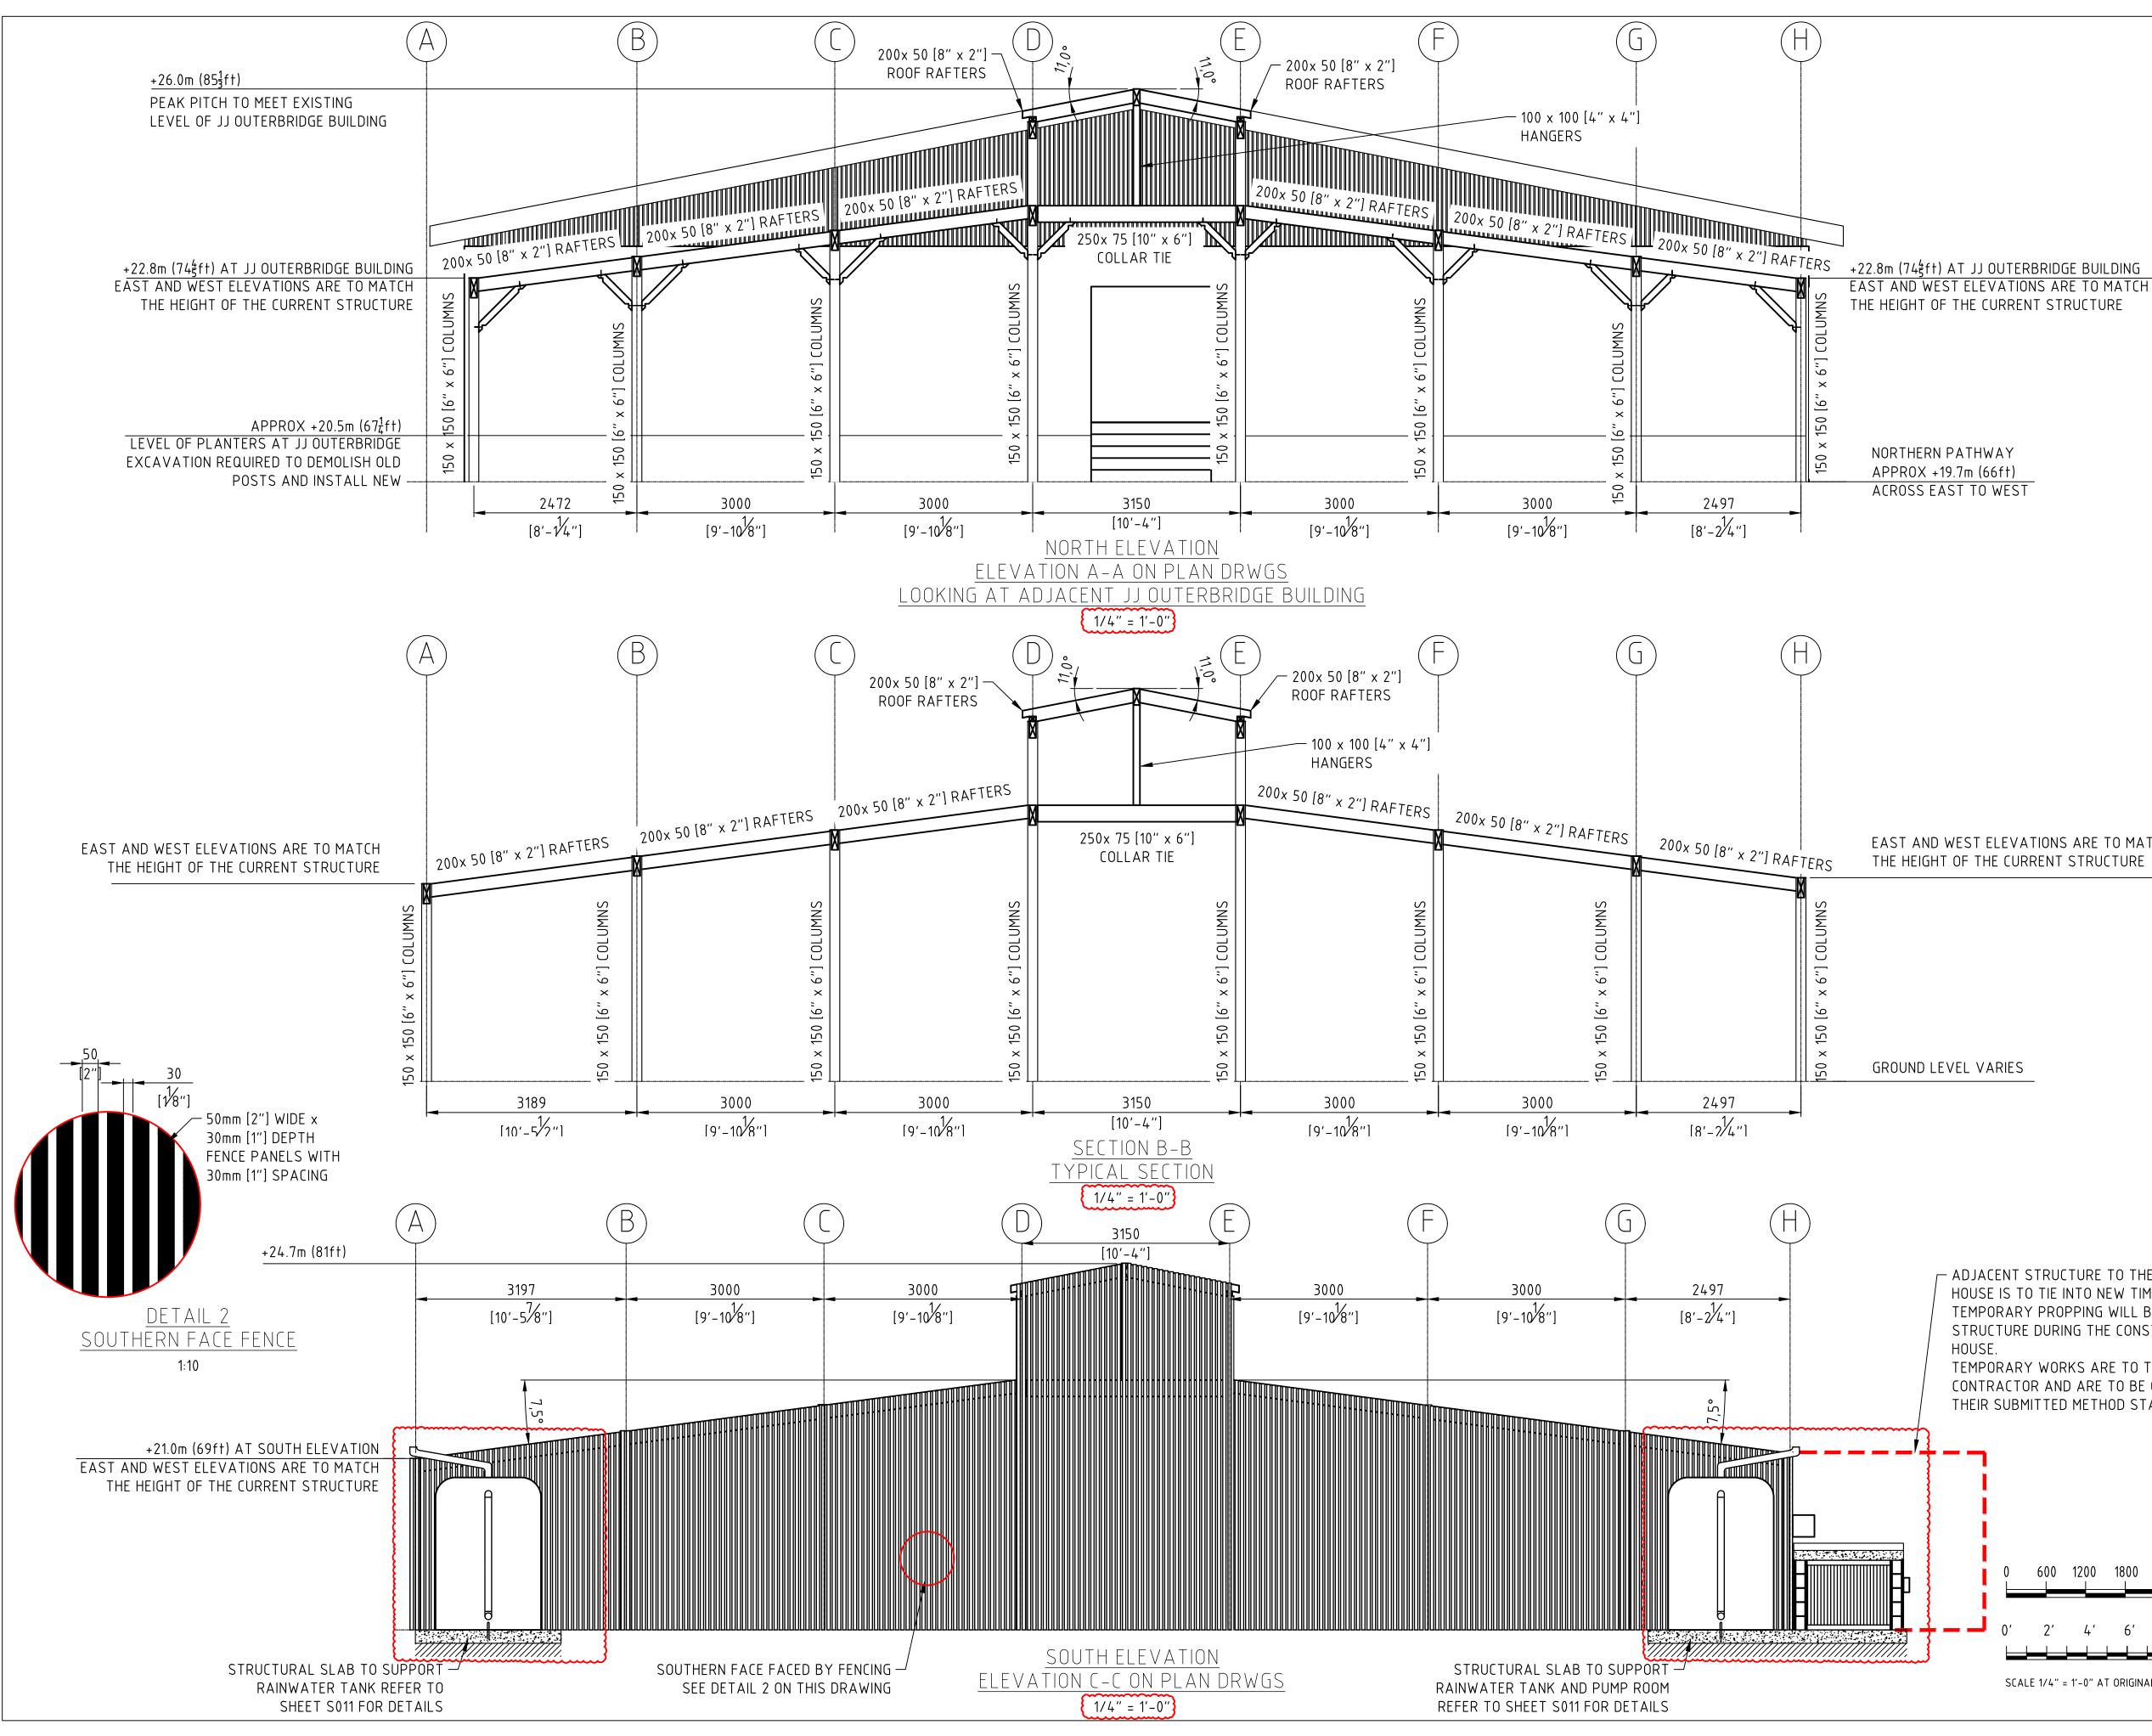

U	Z	4	0	U	10	12
SCALE	1/4" = 1	'-0" AT (ORIGINAL	. SIZE		

600 1200 1800 2400 3000 3600 4200mm

12'

TEMPORARY WORKS ARE TO THE DISCRETION OF THE GENERAL CONTRACTOR AND ARE TO BE CLEARLY DESCRIBED WITHIN THEIR SUBMITTED METHOD STATEMENT

- ADJACENT STRUCTURE TO THE SOUTH EAST OF THE CACTI HOUSE IS TO TIE INTO NEW TIMBER STRUCTURE. TEMPORARY PROPPING WILL BE REQUIRED TO SUPPORT THE STRUCTURE DURING THE CONSTRUCTION OF THE NEW CACTI

EAST AND WEST ELEVATIONS ARE TO MATCH

SHEET NUMBER: S005

REVISION

F

SECTION VIEWS

SHEET TITLE:

COPY FOR ESTIMATING

2024

BOTANICAL GARDENS CACTI HOUSE REFURBISHMENTS

PROJECT NAME:


PREPARED BY: DATE: ____ DESIGN PREPARED BY: DATE: 14/06/24 C.FRASER CHECKED BY: DATE: ____ DRAWING PREPARED BY: DATE: 14/06/24 C.FRASER DATE: CHECKED BY: _ APPROVED BY: DATE: — PROJECT NUMBER:

SCALE: AS SHOWN AT ANSI D

SURVEY

AME	NDMENTS:			
NO	REVISION	ΒY	APP	DATE
Α	FOR TENDER	CF	-	14/06/24
В	REVISED FOLLOWING DESIGN TEAM COMMENTS	CF	-	04/07/24
С	REVISED TO SUIT CLOUD SCAN BY SURVEYOR	CF	-	11/07/24
D	ISSUED FOR BUILDING PERMIT APPLICATION	CF	-	12/07/24
Е	SCALES CHANGED AT REQUEST OF QS	CF		12/08/24
F	TANK SLABS ADDED	CF	-	30/08/24

ISSUED FOR: BUILDING PERMIT APPLICATION

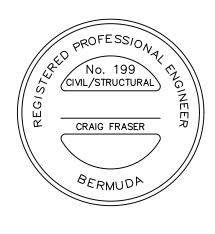



Fax: (441) 295-5658


DEPARTMENT OF WORKS AND ENGINEERING

PUBLIC WORKS P.O. Box HM525 Hamilton HMCX Bermuda Phone: (441) 295-5151

THE MINISTRY OF

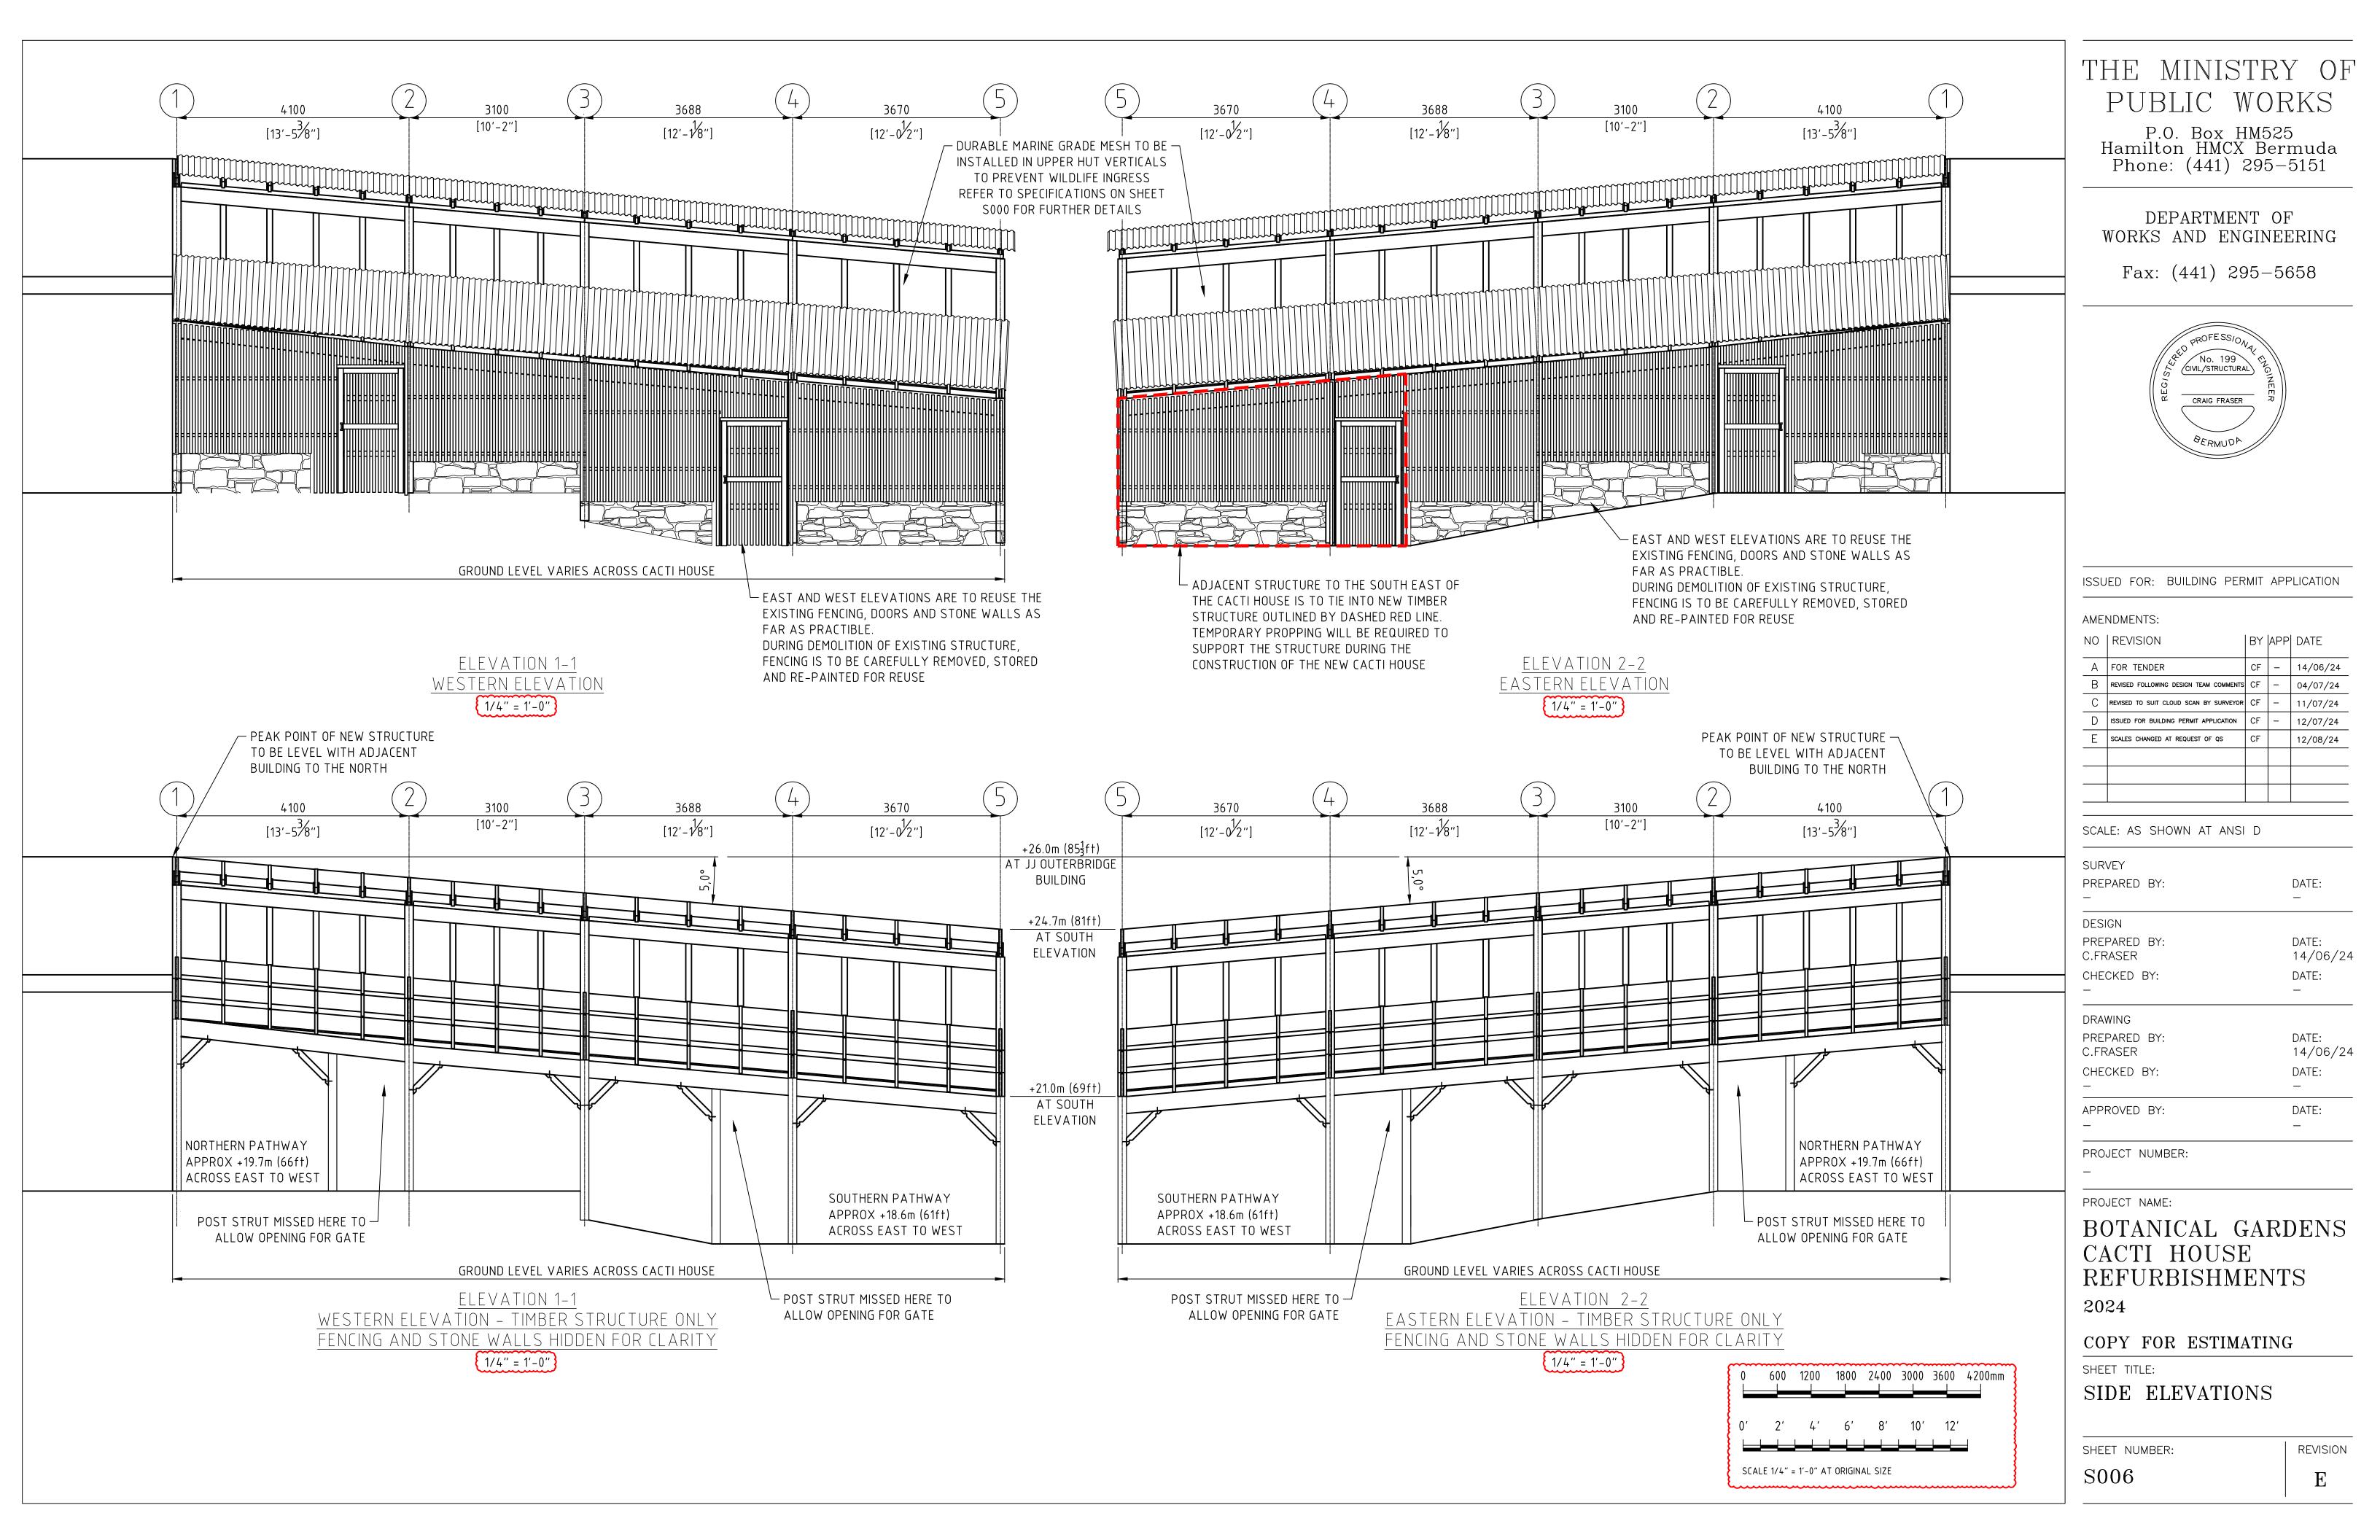

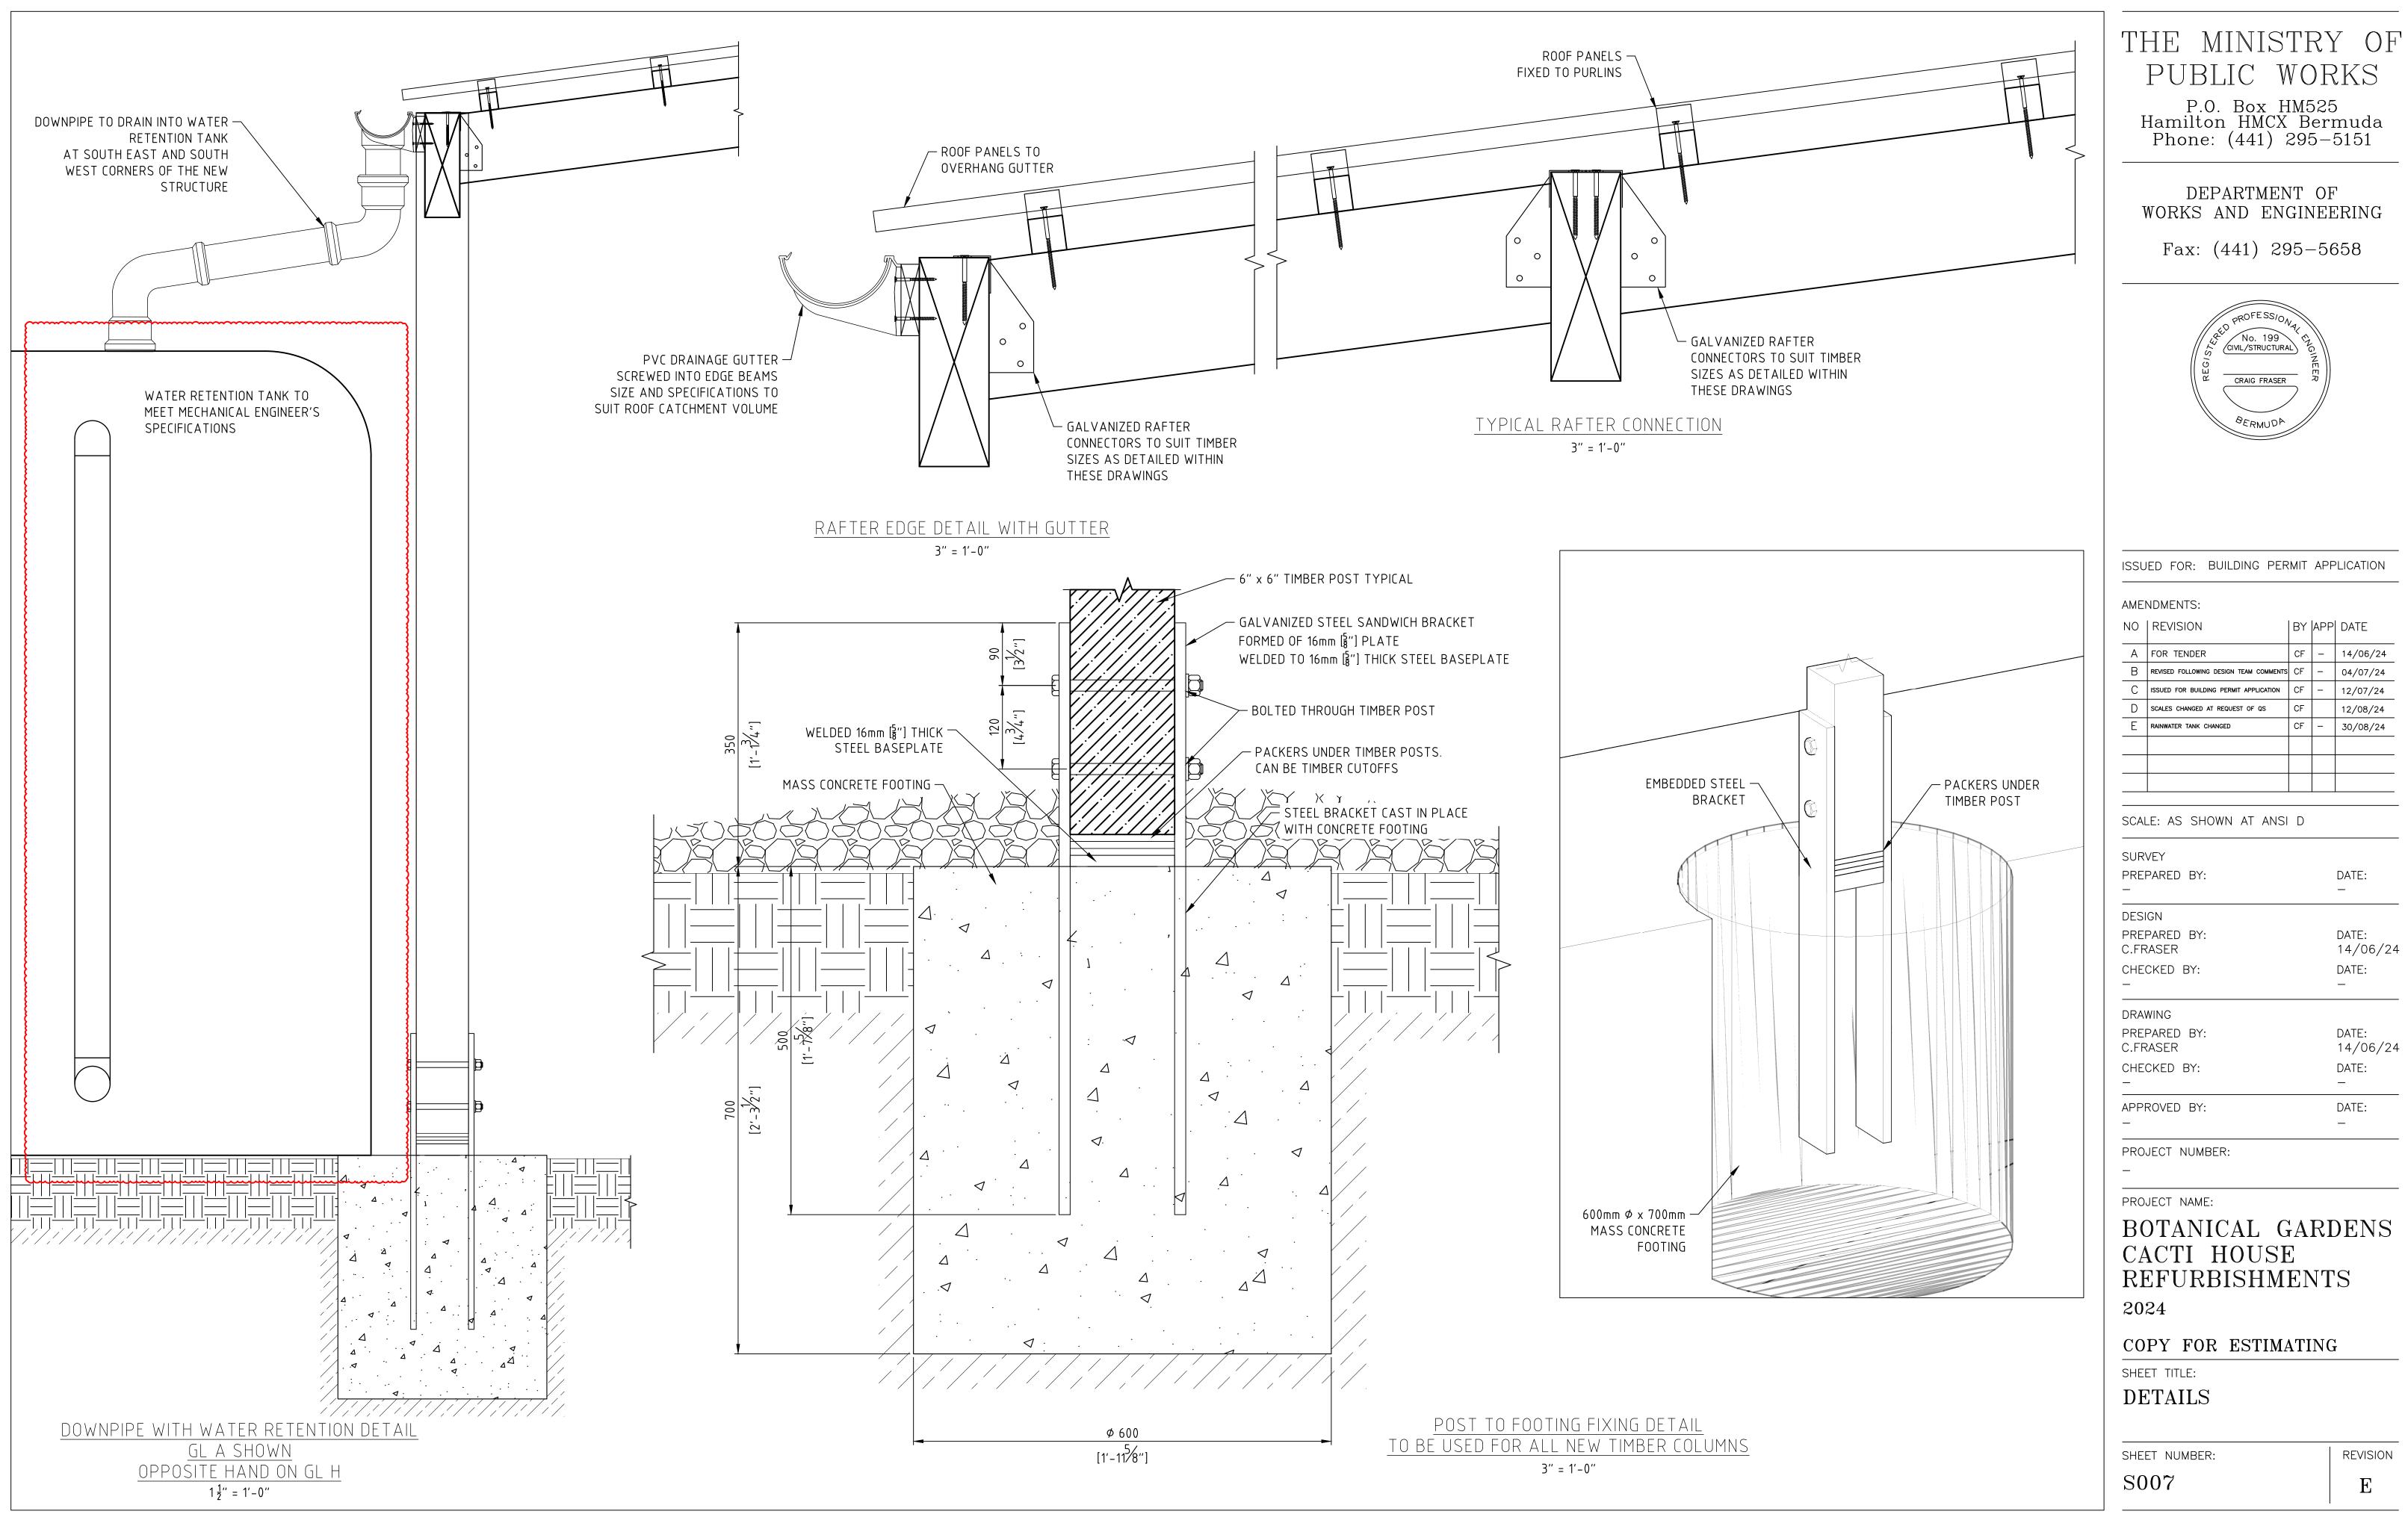

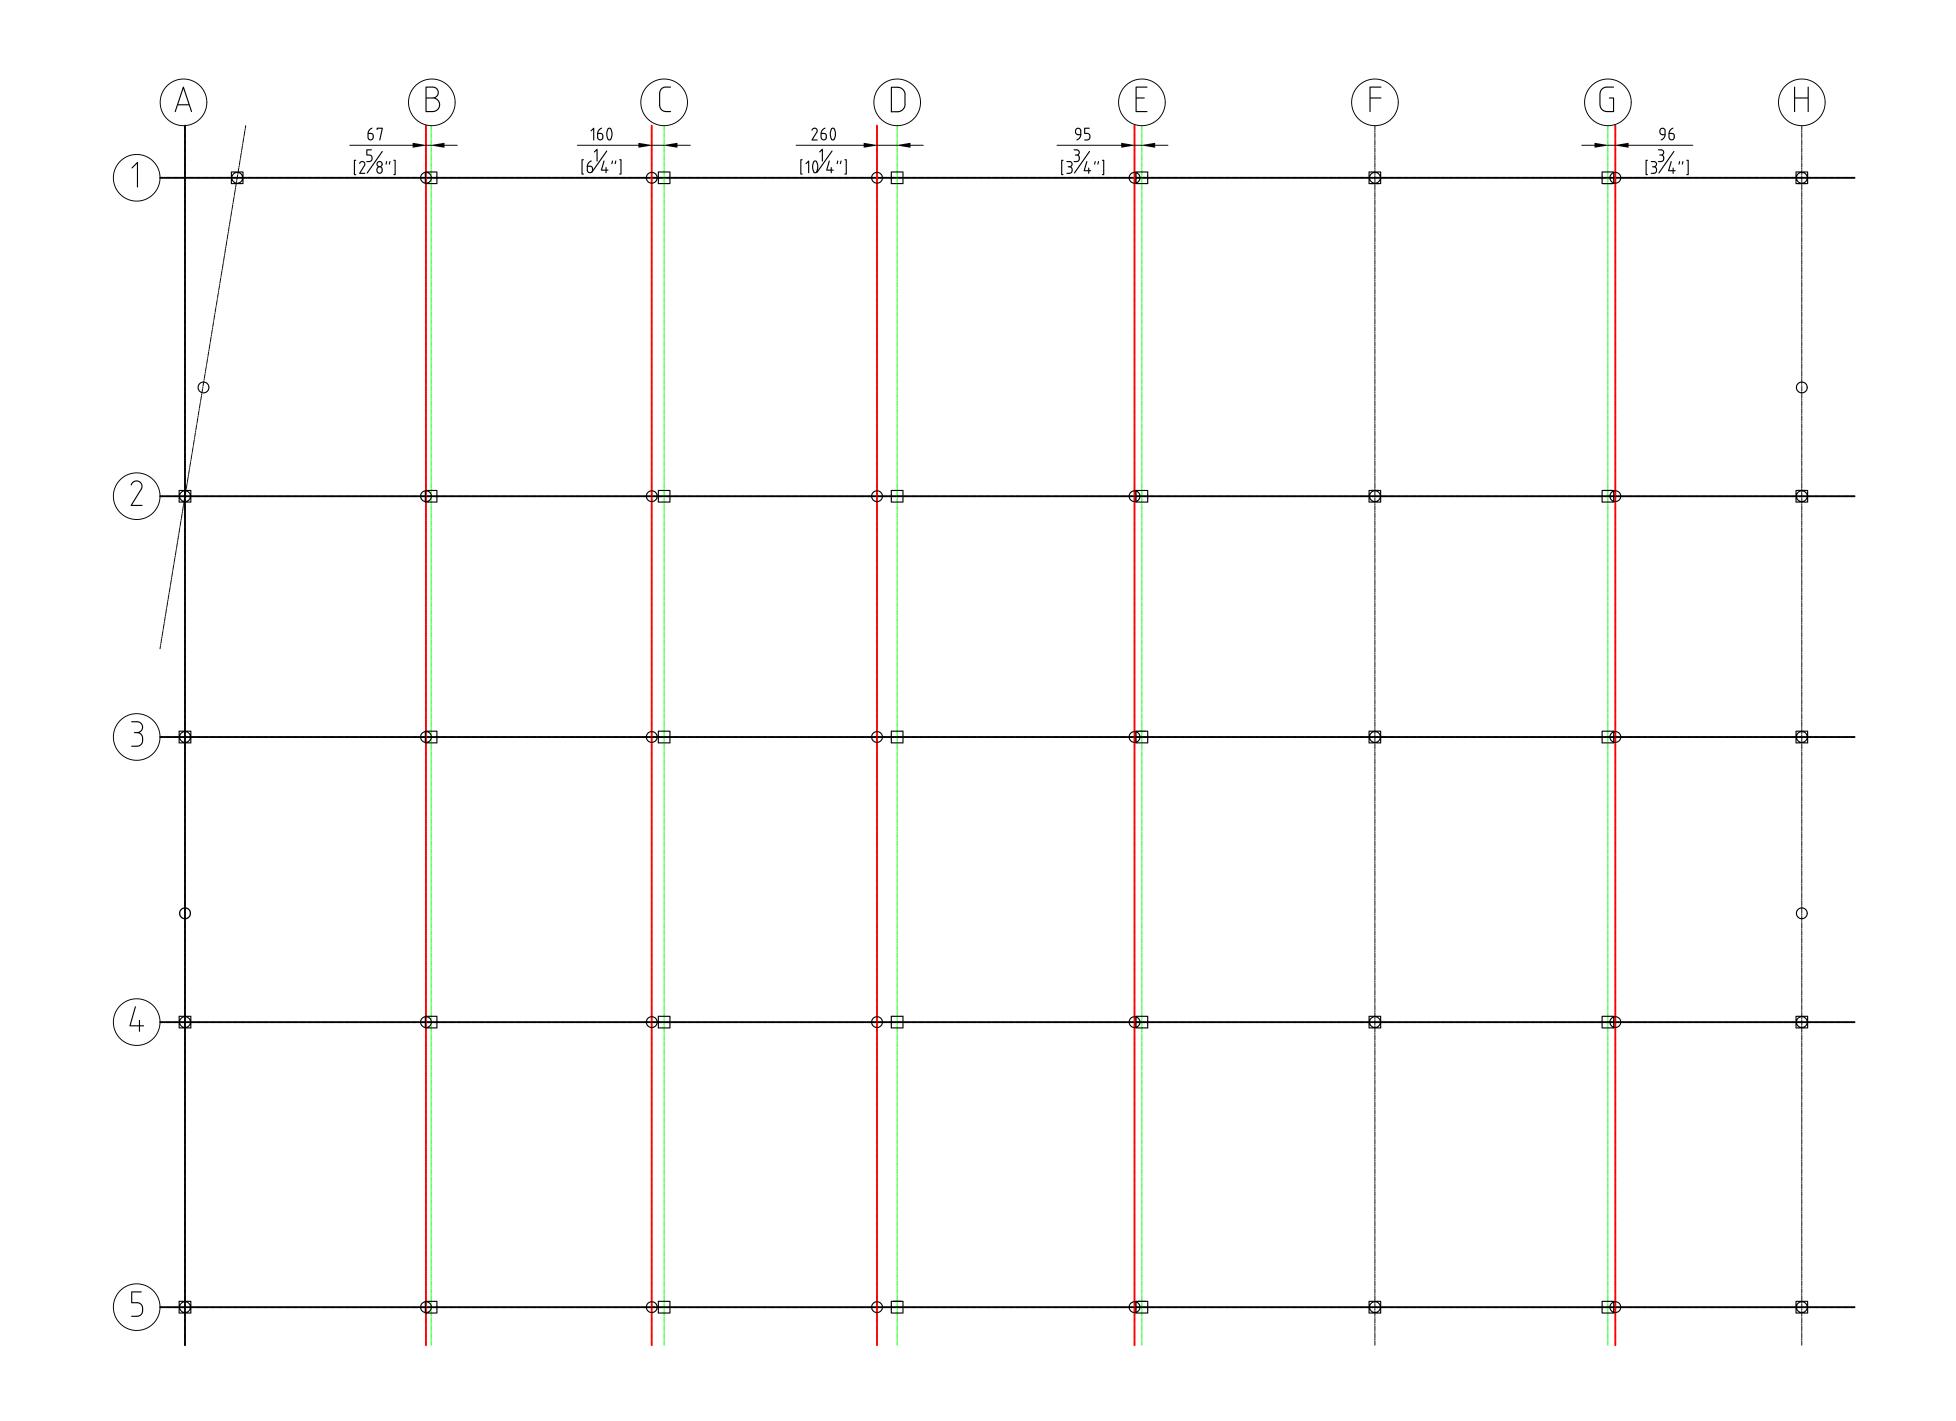

COLUMN L			VS	OLD
	1/4" = 1'-	0"		

THE COLUMN LAYOUT OF THE NEW STRUCTURE IS MARGINALLY DIFFERENT TO THE OLD STRUCTURE TO BETTER ALIGN WITH THE ADJACENT NORTHERN BUILDING AND EVEN OUT COLUMN SPACINGS

RED GRIDLINES SHOW THE OLD COLUMN LAYOUT AND GREEN SHOW THE NEW, WITH DIMENSIONS INCLUDED TO HIGHLIGHT THE CHANGE. WHEN GRIDLINES ARE BLACK, THERE IS NO DIFFERENCE BETWEEN OLD AND NEW

~	600	1200	1800	2400	3000	3600	4200mm
1	2'	4'	6'	8'	10'	12'	
AL	E 1/4" =	= 1'-0'' A1	origin/	AL SIZE			

SHEET NUMBER:	
S008	

REVISION

DATE: 14/06/24

D

OLD VS NEW LAYOUT

SHEET TITLE:

2024

COPY FOR ESTIMATING

COLUMN LAYOUT

CACTI HOUSE REFURBISHMENTS

PROJECT NAME: BOTANICAL GARDENS

PREPARED BY: C.FRASER

DATE: CHECKED BY: _ _ DATE: APPROVED BY: — — PROJECT NUMBER: _


SURVEY DATE: PREPARED BY: _ ____ DESIGN PREPARED BY: DATE: 14/06/24 C.FRASER DATE: CHECKED BY: _ — DRAWING

NO | REVISION | BY |APP| DATE CF - 14/06/24 A FOR TENDER B REVISED FOLLOWING DESIGN TEAM COMMENTS CF 04/07/24 C ISSUED FOR BUILDING PERMIT APPLICATION CF 12/07/24 D SCALES CHANGED AT REQUEST OF QS 12/08/24 CF

SCALE: AS SHOWN AT ANSI D

AMENDMENTS:


ISSUED FOR: BUILDING PERMIT APPLICATION

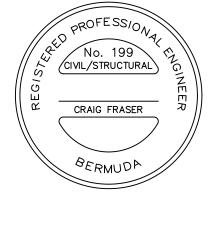



DEPARTMENT OF WORKS AND ENGINEERING


Fax: (441) 295-5658

THE MINISTRY OF PUBLIC WORKS P.O. Box HM525 Hamilton HMCX Bermuda Phone: (441) 295–5151

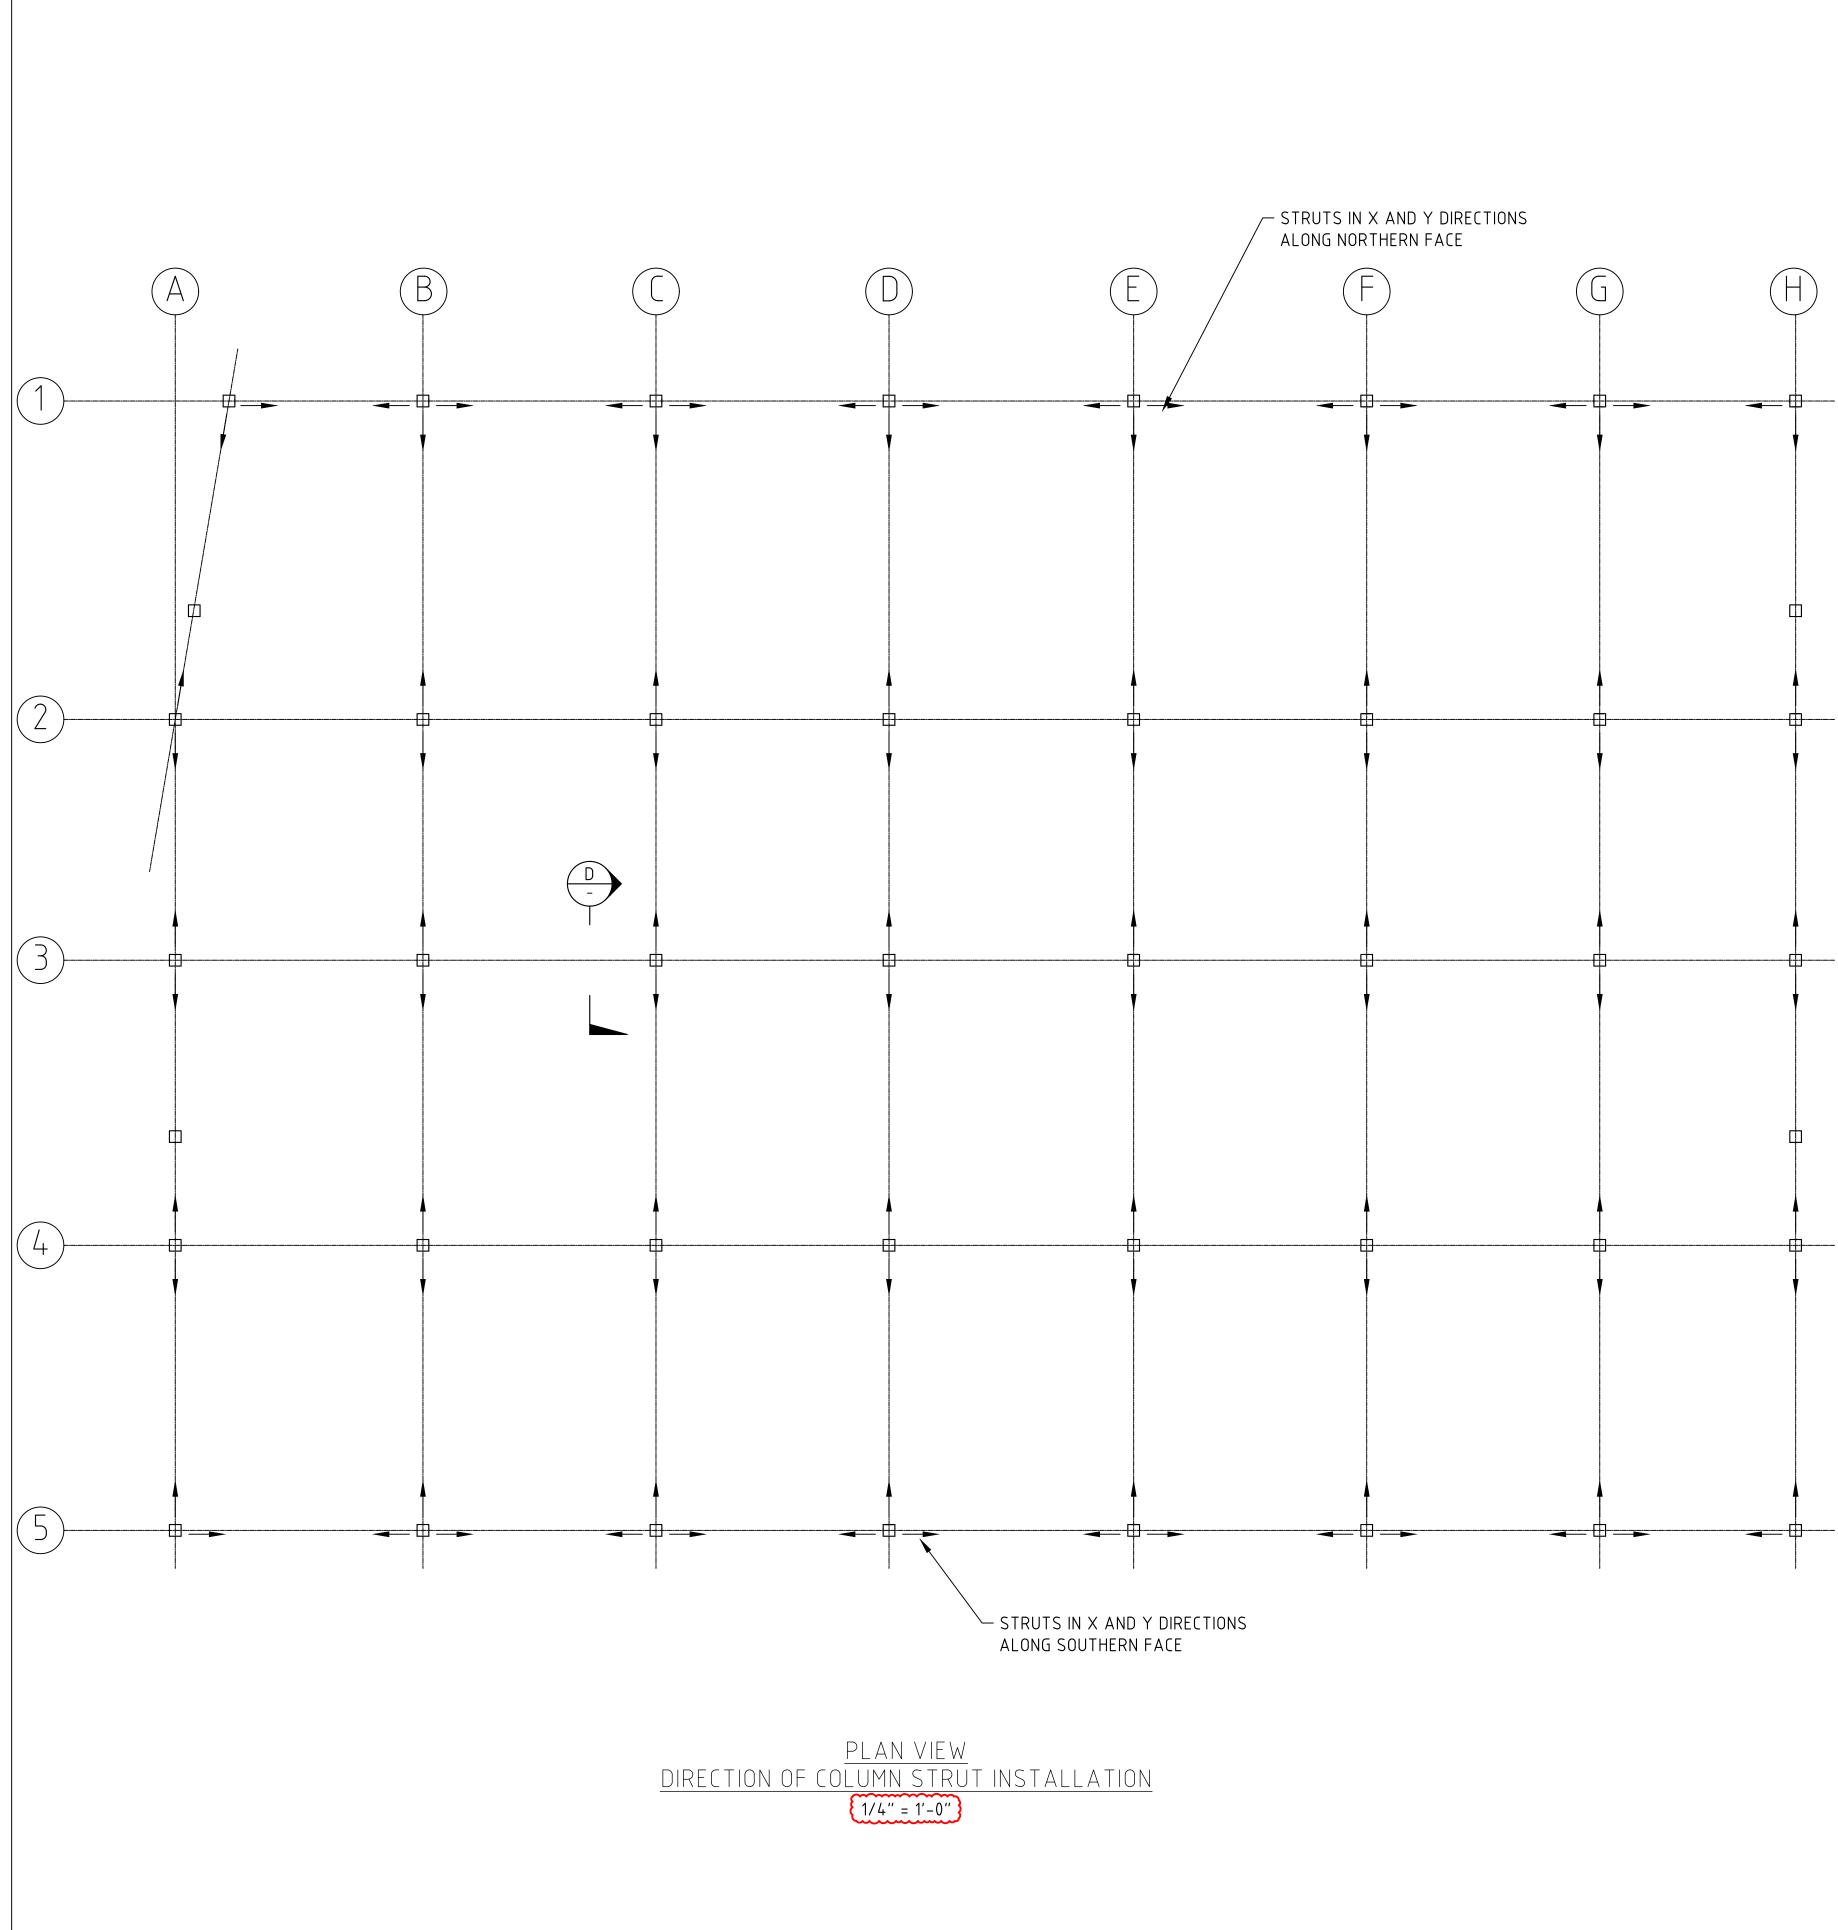


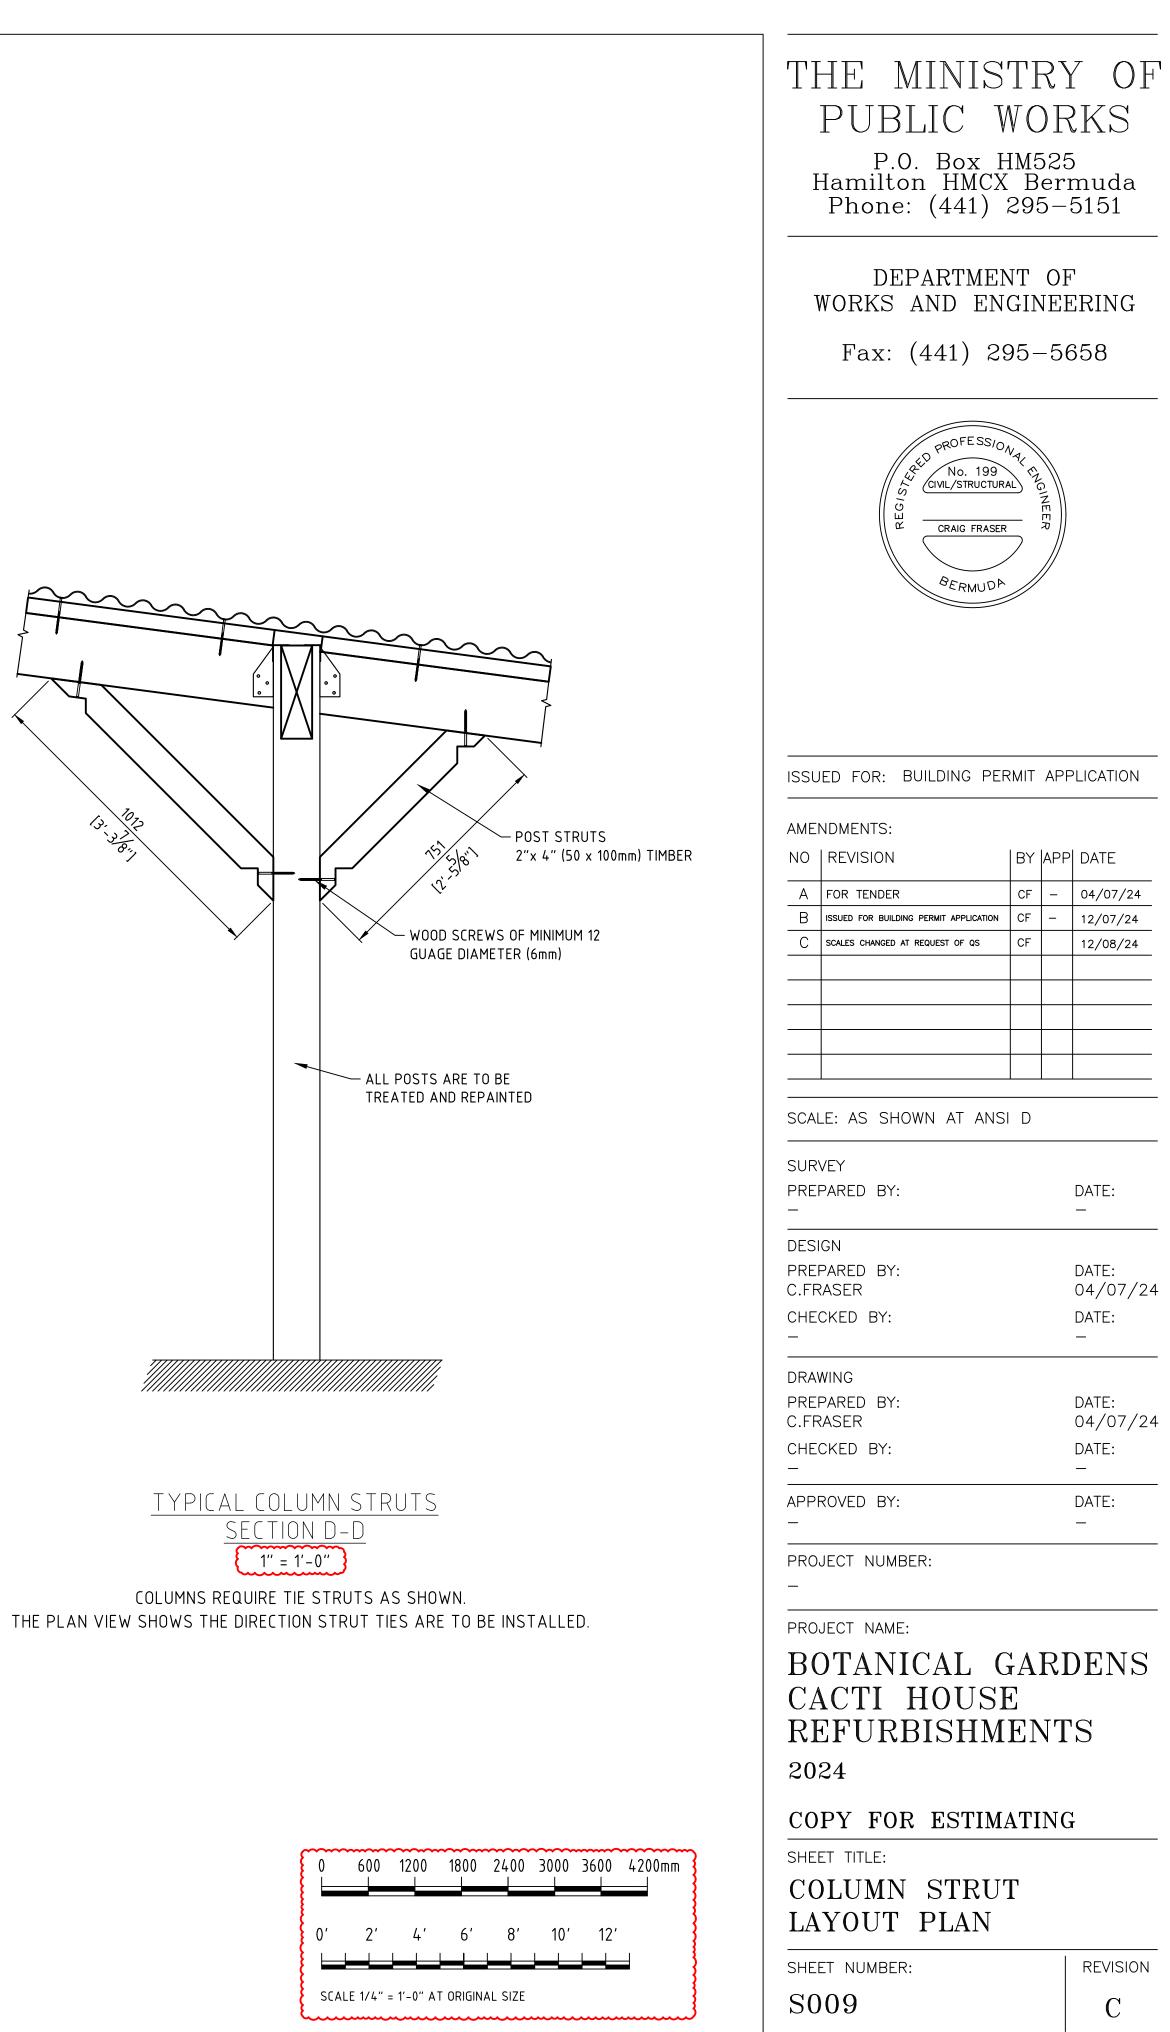

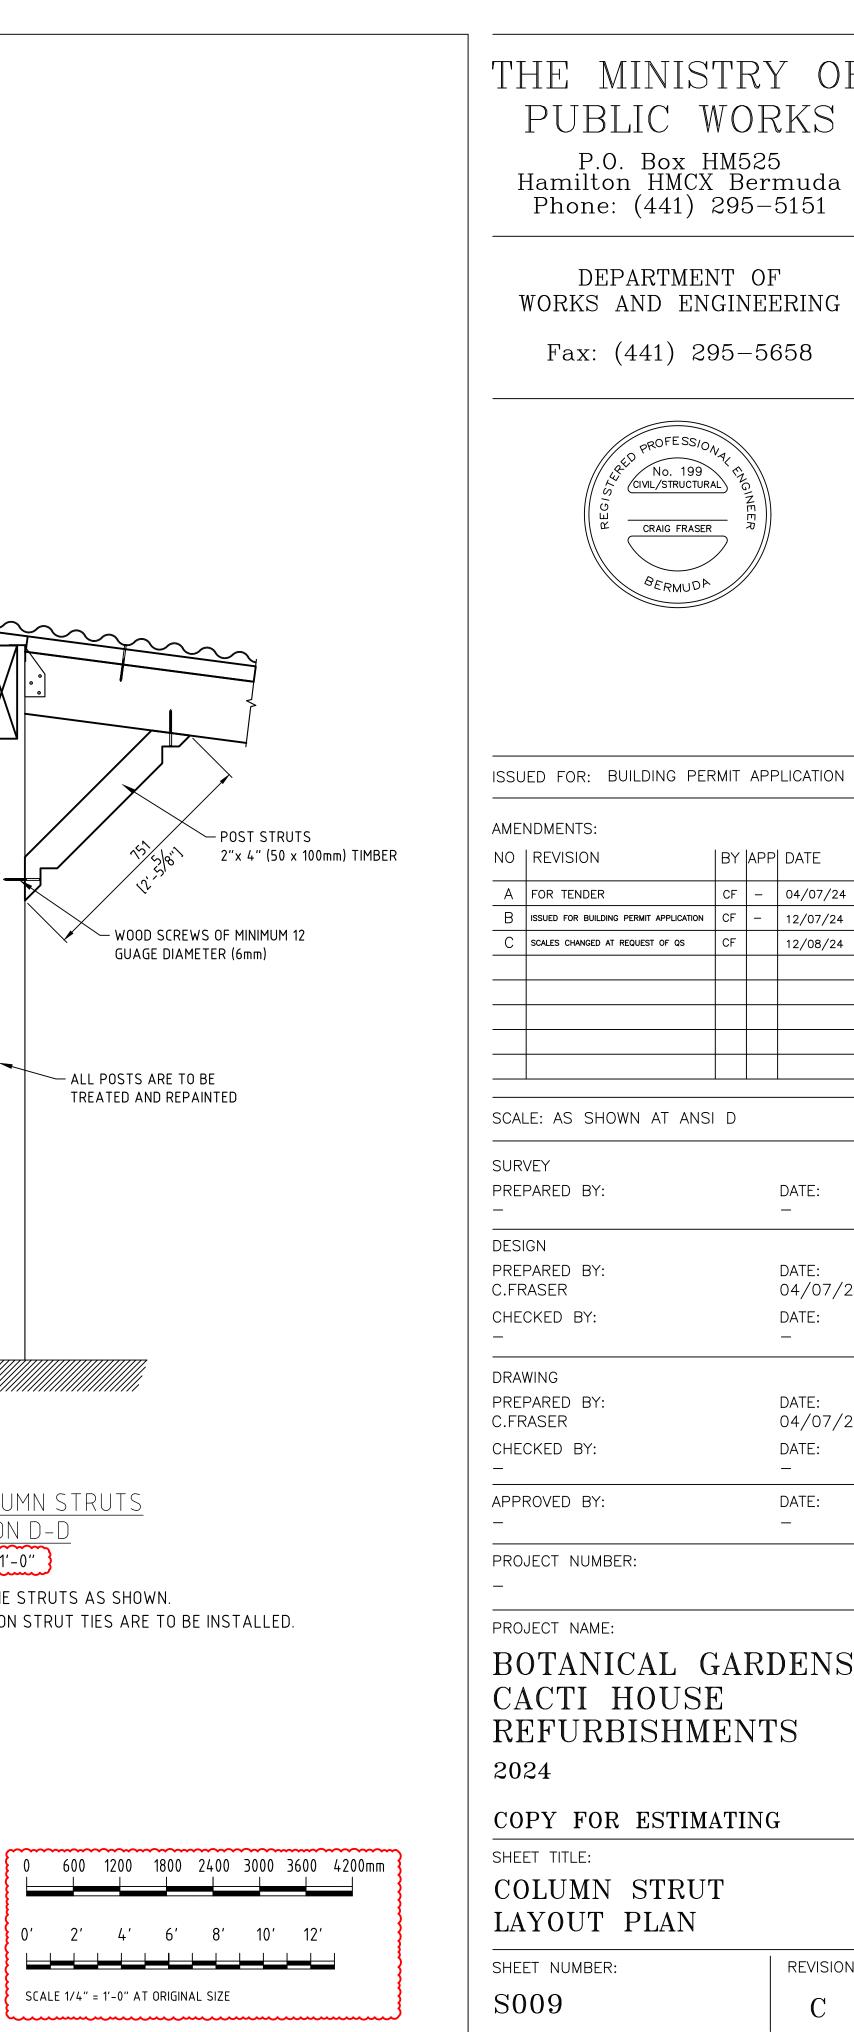

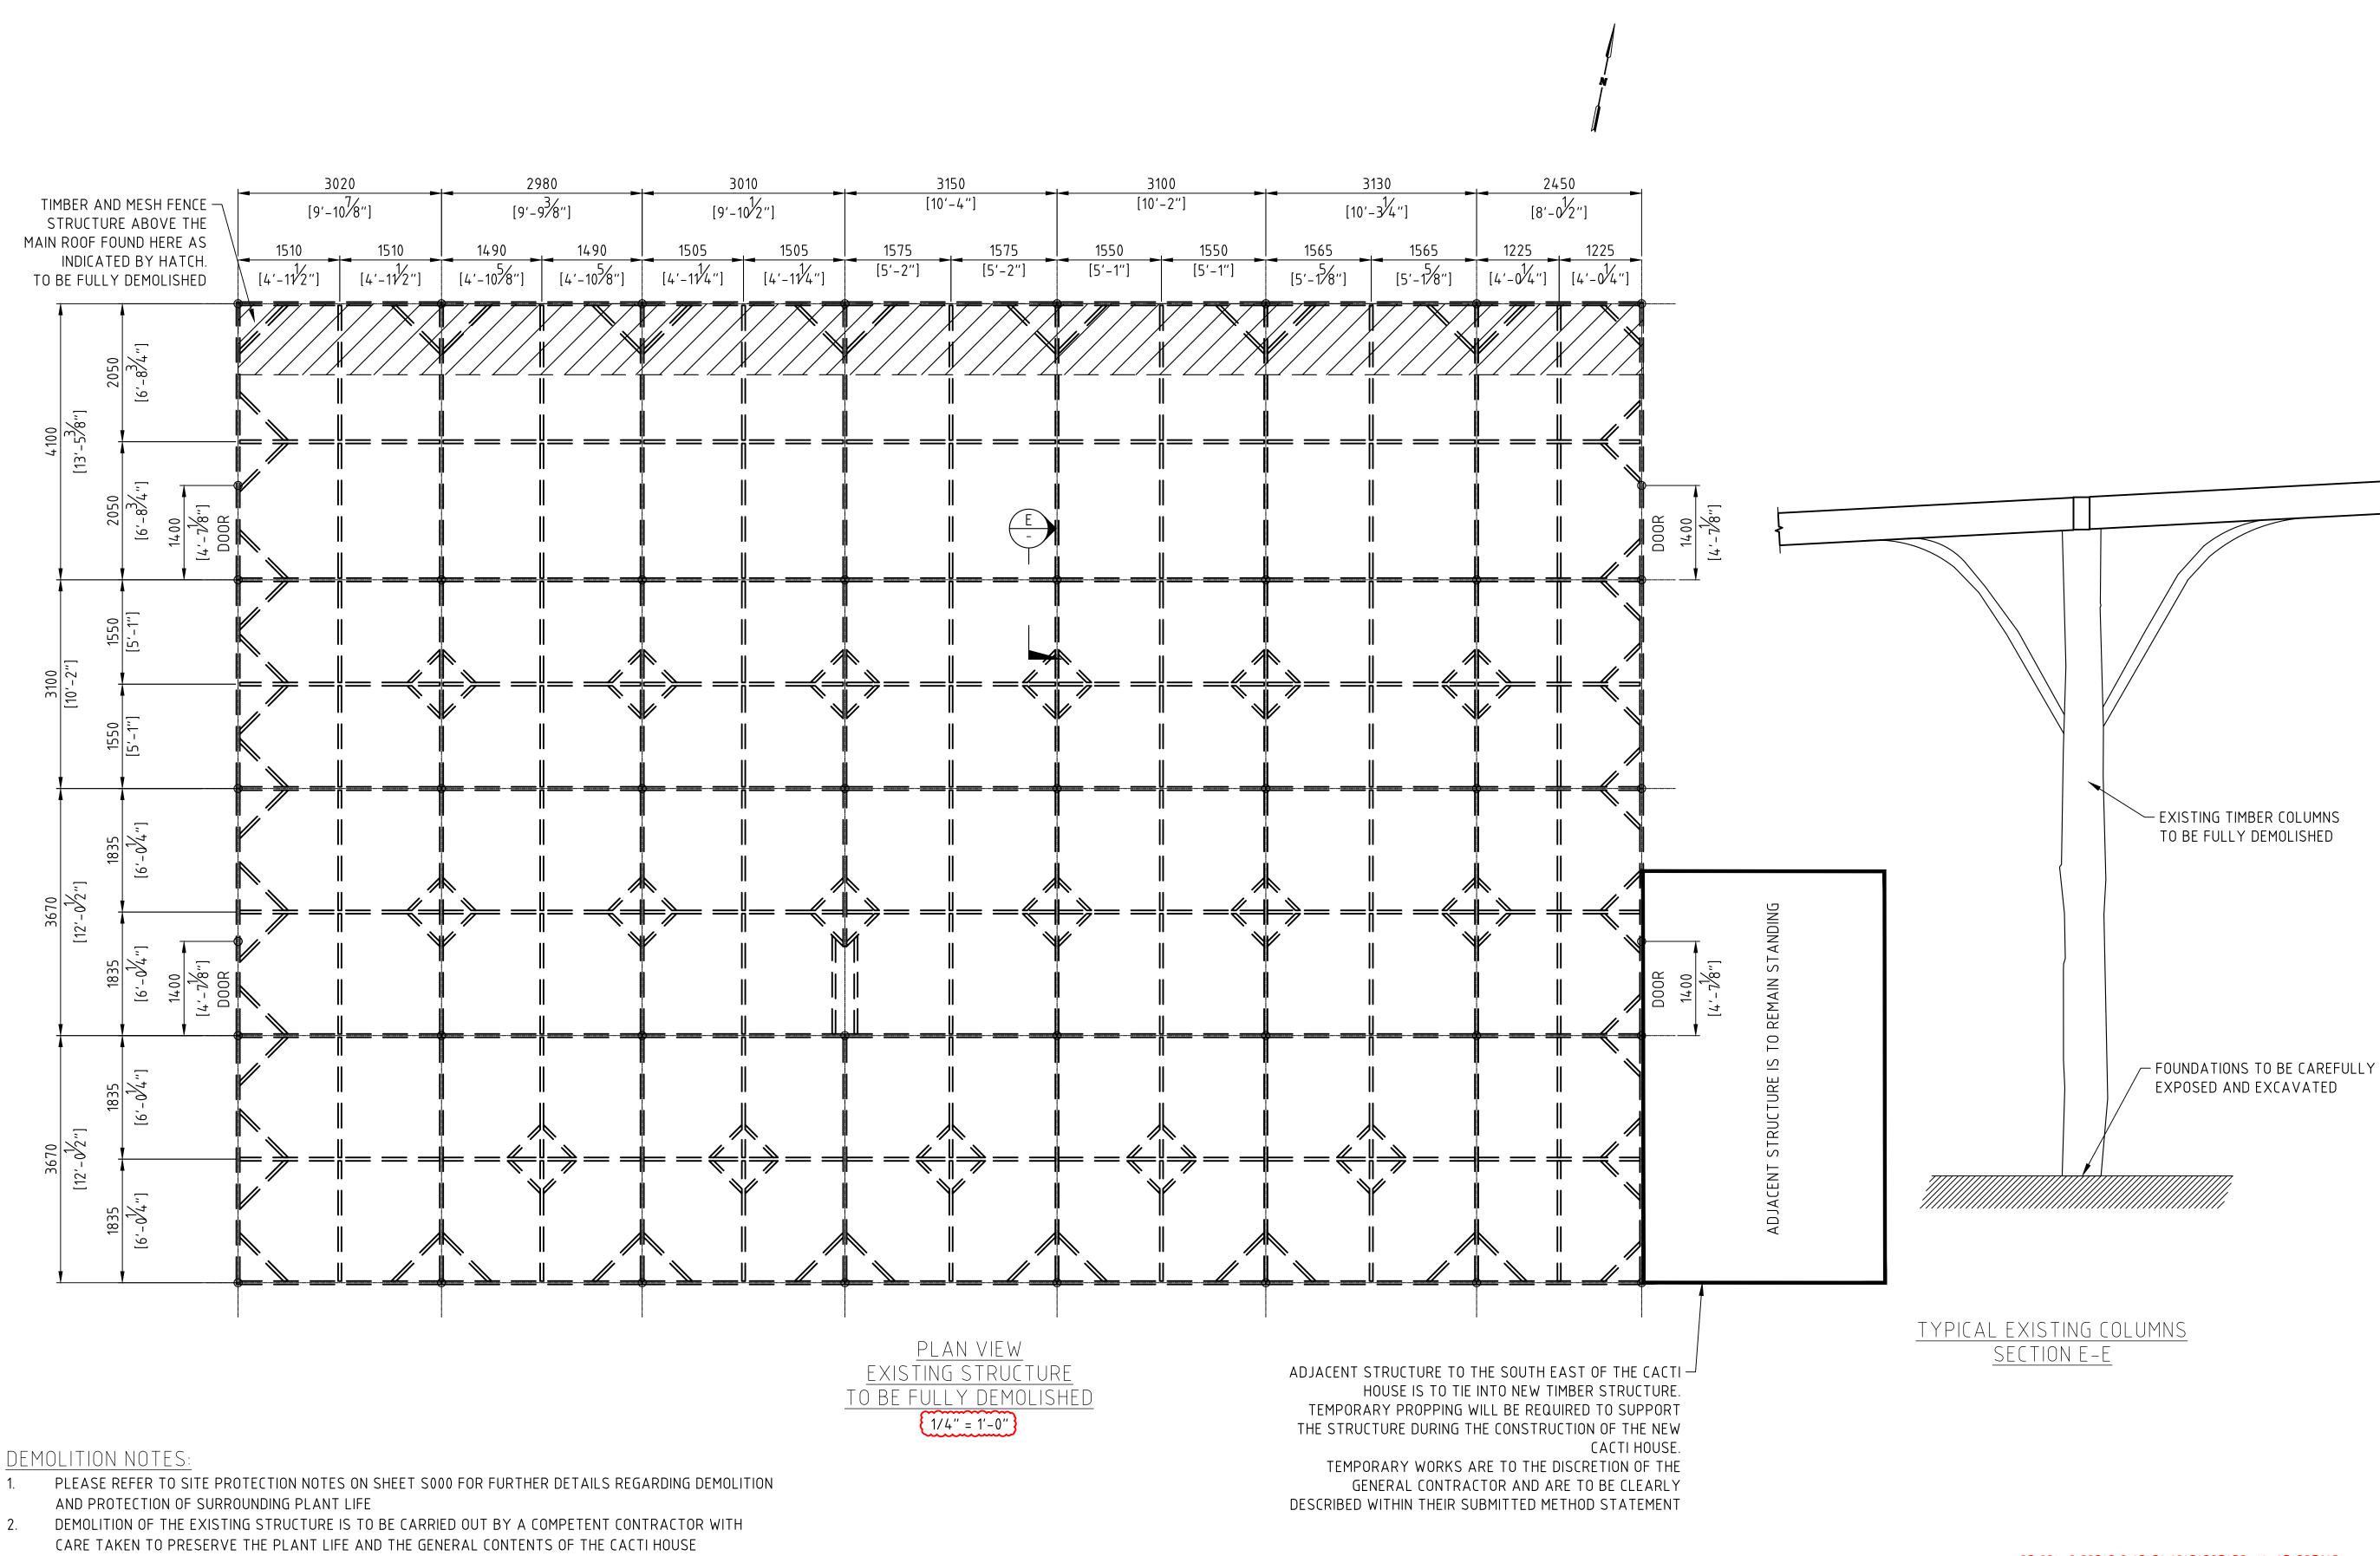

- 1. PLEASE REFER TO SITE PROTECTION NOTES ON SHEET S000 FOR FURTHER DETAILS REGARDING DEMOLITION
- 2. 3. ALL EXISTING TIMBER STRUCTURE AS SHOWN IN HATCHED LINES ON THIS DRWG IS TO BE FULLY REMOVED AND THE COLUMN FOUNDATIONS ARE TO BE EXPOSED AND EXCAVATED
- 4. THE ADJACENT STRUCTURE AT THE SOUTH EAST END OF THE CACTI HOUSE IS TO BE ADEQUATELY PROPPED. THE TEMPORARY WORKS DESIGN IS THE RESPONSIBILITY OF THE GENERAL CONTRACTOR
- 5. EAST AND WEST ELEVATIONS ARE TO REUSE THE EXISTING FENCING, DOORS AND STONE WALLS AS FAR AS PRACTIBLE. DURING DEMOLITION OF EXISTING STRUCTURE, FENCING IS TO BE CAREFULLY REMOVED, STORED AND RE-PAINTED FOR REUSE

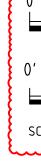

~~~	600	1200	1800	2400	3000	3600	4200mm
,	2'	4'	6'	8'	10'	12'	
							_

S0	1	0	

SHEET NUMBER:

REVISION

С

DEMOLITION PLAN EXISTING STRUCTURE

SHEET TITLE:

COPY FOR ESTIMATING

2024

—

_

BOTANICAL GARDENS CACTI HOUSE REFURBISHMENTS

PROJECT NAME:

PROJECT NUMBER:

C.FRASER	04/07/24
CHECKED BY:	DATE:
-	_
DRAWING	
PREPARED BY: C.FRASER	DATE: 04/07/24
CHECKED BY:	DATE:
	_
APPROVED BY:	DATE:

SURVEY PREPARED BY:

DESIGN

PREPARED BY:

SCALE: AS SHOWN AT ANSI D

AMENDMENTS:

NO | REVISION

CF - 04/07/24 A FOR TENDER B ISSUED FOR BUILDING PERMIT APPLICATION CF 12/07/24 SCALES CHANGED AT REQUEST OF QS CF 12/08/24


| BY | APP | DATE

DATE:

DATE:

____

ISSUED FOR: BUILDING PERMIT APPLICATION

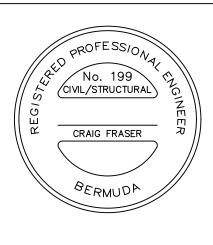

DEPARTMENT OF WORKS AND ENGINEERING


THE MINISTRY OF

PUBLIC WORKS

P.O. Box HM525 Hamilton HMCX Bermuda

Phone: (441) 295-5151

Fax: (441) 295-5658

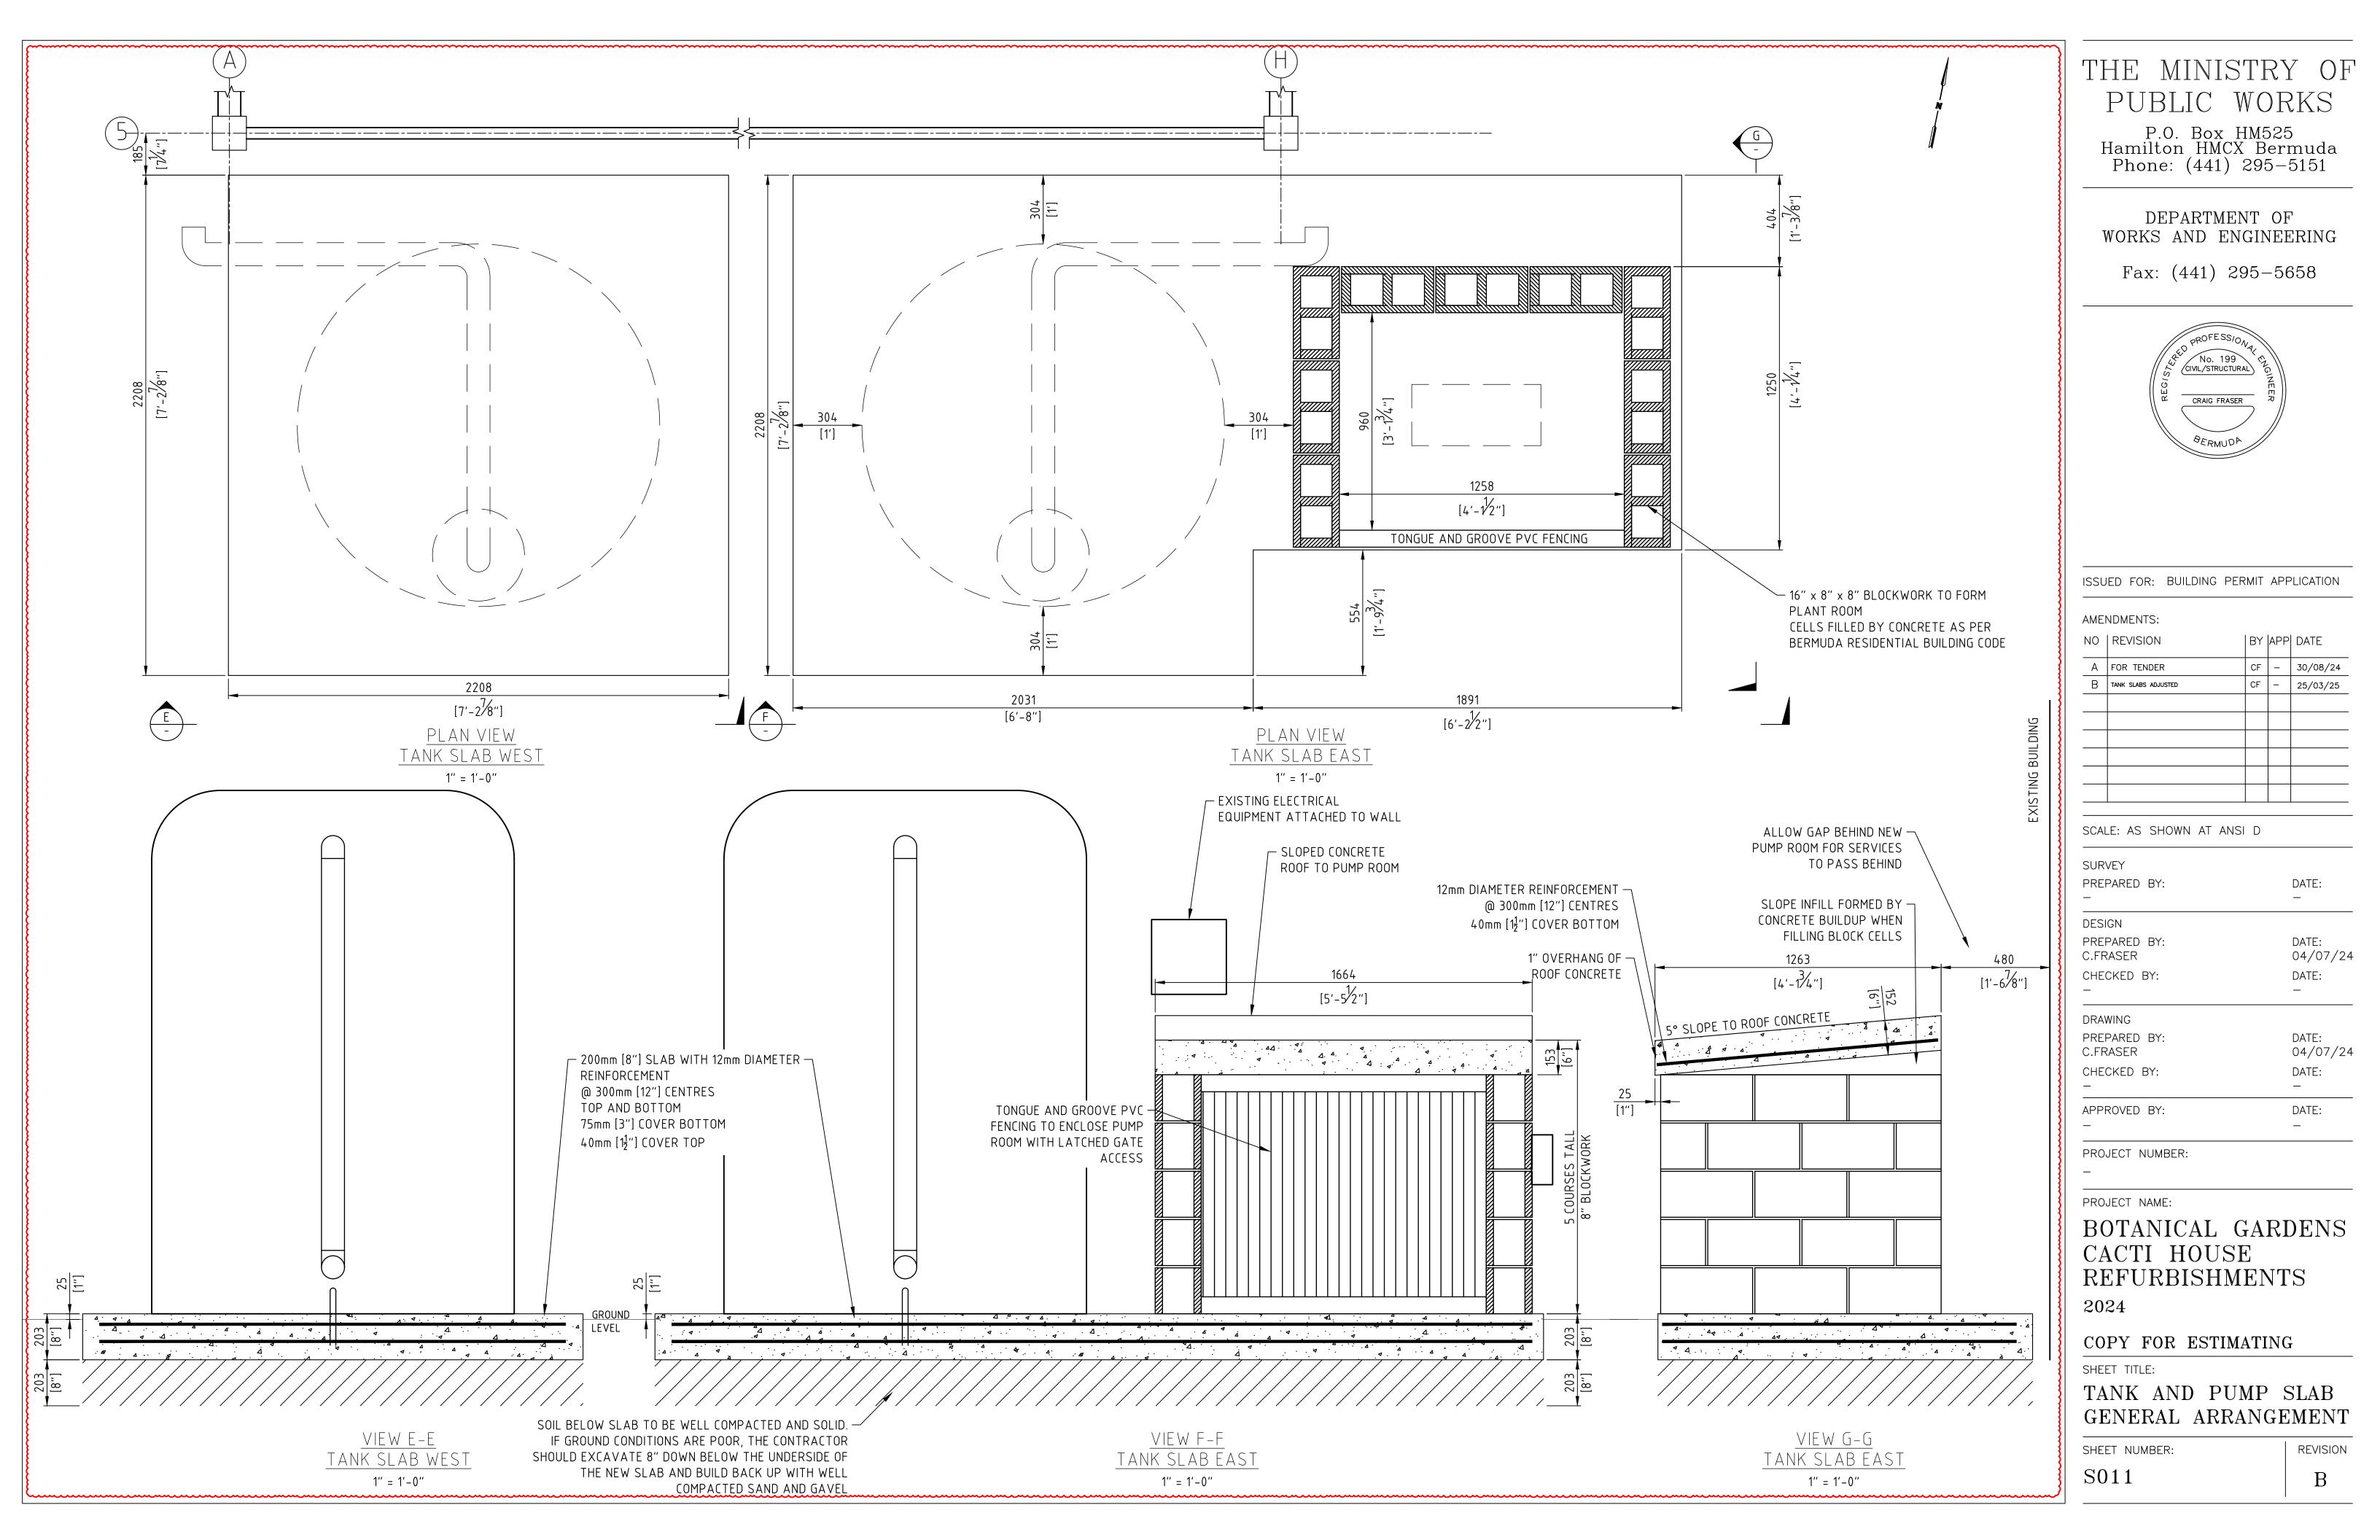

# **BOTANICAL GARDENS CACTI BUILDING** WATER STORAGE SYSTEM

- A. BERMUDA DEPARTMENT OF PLANNING NOTES
- 1. ALL WORK SHALL COMPLY WITH APPLICABLE SECTIONS OF ALL LOCAL CODES AND AMENDMENTS TO DATE, INCLUDING BUT NOT LIMITED TO THE FOLLOWING:
- a. BERMUDA BUILDING CODE 2014 (ADOPTED FROM IBC 2012)
- b. BERMUDA MECHANICAL CODE 2014 (ADOPTED FROM IMC 2012)
- c. BERMUDA ELECTRICAL CODE 2014 (ADOPTED FROM NEC 2011) d. BERMUDA PLUMBING CODE 2014 (ADOPTED FROM IPC 2012)
- e. BERMUDA ENERGY CONSERVATION CODE 2014 (ADOPTED FROM IECC
- 2012)
- c. BERMUDA FIRE CODE 2014 (ADOPTED FROM NFPA STANDARDS)
- 2. ALL WORK SHALL COMPLY WITH THE REQUIREMENTS OF OF ALL APPLICABLE REFERENCE STANDARDS, INCLUDING BUT NOT LIMITED TO THE FOLLOWING: a. ANSI
- b. ASPE
- c. ASHRAE STANDARD 90.1: ENERGY STANDARD FOR BUILDINGS
- 3. ALL WORK SHALL BE SUBJECT TO SPECIAL INSPECTIONS AS APPLICABLE a. WIND RESISTANCE (IBC SECTION 1705.10)
  - SPRAYED FIRE-RESISTANT MATERIALS (IBC SECTION 1705.13) MASTIC AND INTUMESCENT FIRE RATED COATINGS (IBC SECTION 1705.14)
- d. FIRE RESISTANT PENETRATION AND JOINTS (IBC SECTION 1705.16) e. ENERGY CODE INSPECTIONS
- 4. ALL WORK SHALL COMPLY WITH THE GOVERNMENT OF BERMUDA LAWS AND REGULATIONS, INCLUDING BUT NOT LIMITED TO:
- a. BERMUDA PUBLIC HEALTH ACT 1949 b. BERMUDA OCCUPATIONAL SAFETY & HEALTH REGULATIONS 2009
- B. OCCUPATIONAL HEALTH, SAFETY AND ENVIRONMENT (OHSE) REQUIREMENTS
- 5. THE CONTRACTOR SHALL PROVIDE DIRECT SUPERVISION OVER THEIR WORKFORCE ON SITE, AND ENSURE THEIR WORK CONFORMS TO OHSE POLICIES.
- 6. THE CONTRACTOR SHALL SUPPLY AND UTILIZE THE APPROPRIATE PERSONAL PROTECTION EQUIPMENT (PPE) FOR ALL WORKS.
- 7. THE CONTRACTOR SHALL OBTAIN ALL NECESSARY AND APPLICABLE PERMITS OR APPROVALS.
- THE CONTRACTOR SHALL ELIMINATE OR CONTROL ALL SAFETY HAZARDS AND POTENTIAL ENVIRONMENTAL IMPACTS ASSOCIATED WITH THE PROJECT.
- C. GENERAL NOTES
- 1. REMOVAL AND RELOCATION OF CERTAIN EXISTING WORK WILL BE NECESSARY FOR THE PERFORMANCE OF THE WORK. EXISTING CONDITIONS ARE NOT COMPLETELY DETAILED ON THE DRAWINGS. CONTRACTOR SHALL SURVEY THE SITE AND INCLUDE ALLOWANCE FOR SUCH REMOVALS AND RELOCATIONS.
- 2. WORK SHALL BE DONE WHEN AND AS DIRECTED AND SHALL BE PERFORMED SO AS TO CAUSE THE LEAST POSSIBLE INCONVENIENCE AND DISTURBANCE TO THE SURROUNDING POPULATION. PLAN INSTALLATION OF NEW WORK AND CONNECTIONS TO EXISTING WORK TO AVOID INTERFERENCE WITH REGULAR OPERATION OF EXISTING FACILITIES.
- 3. MATERIALS, DOCUMENTATION AND WORKMANSHIP SHALL BE IN ACCORDANCE WITH LOCAL CODES, REFERENCE STANDARDS, AND AS SPECIFIED.
- 4. DISCONNECT, REMOVE AND/OR RELOCATE EXISTING MATERIALS, EQUIPMENT AND OTHER WORK AS NOTED OR REQUIRED FOR PROPER INSTALLATION OF NEW WORK.
- 5. FIREPROOFING AND INSULATION DISTURBED BY NEW CONSTRUCTION SHALL BE RESTORED TO ORIGINAL CONDITION.
- 6. SUPPORT ALL PIPING AND/OR EQUIPMENT FROM BUILDING STRUCTURE, FLOORS, AND BURIED IN TRENCH IN AN APPROVED MANNER. WHERE OVERHEAD CONSTRUCTION DOES NOT PERMIT FASTENING OF SUPPORTS FOR EQUIPMENT, FURNISH ADDITIONAL FRAMING.
- 7. SEAL OPENINGS AROUND PIPING THROUGH WALLS AND FOUNDATION SLABS IN AN APPROVED MANNER USING MINERAL WOOL OR OTHER NON-COMBUSTIBLE MATERIAL. ALL PENETRATIONS SHALL BE FIRE-PROOFED, AS REQUIRED.
- 8. CONTRACTOR TO PROVIDE FULLY COORDINATED SHOP DRAWINGS AND SUBMITTALS FOR THE ENGINEER'S REVIEW PRIOR TO PROCUREMENT, FABRICATION, OR INSTALLATION OF NEW WORK.
- 9. CONTRACTOR SHALL USE EXTREME CAUTION WHEN INSTALLING FIXTURES OR PIPING ON OR IN FINISHED WALLS AND PARTITIONS.
- 10. PROVIDE ANGLE STOPS ON WATER PIPING AT ALL FIXTURES.
- 11. CONTRACTOR SHALL VERIFY EXACT LOCATION OF EXISTING PIPING IN FIELD BEFORE ANY INSTALLATION OF NEW WORK.
- 12. FOR EXACT LOCATION OF PLUMBING FIXTURES, REFER TO ARCHITECTURAL DRAWINGS.

- 13. ALL PLUMBING WORK SHALL COMPLY WITH BUILDING STANDARDS AND REQUIREMENTS
- 14. ALL NEW PLUMBING FIXTURES SHALL COMPLY WITH WATER CONSERVATION LAWS. 15. ALL FIXTURES SHALL BE AS SPECIFIED BY ARCHITECT, FURNISHED AND INSTALLED
- BY PLUMBING CONTRACTOR.
- 16. CONTRACTOR SHALL PROVIDE TRAP PRIMERS FOR ALL FLOOR DRAINS
- 17. CONTRACTOR SHALL PROVIDE ACCESS DOORS TO ALL DOMESTIC WATER VALVES

AND TRAP PRIMERS.

- 18. CONTRACTOR SHALL PROVIDE WATER HAMMER ARRESTORS ON ALL QUICK CLOSING FIXTURES.
- 19. CONTRACTOR TO FIRE PROOF AND SEAL ALL PENETRATIONS THROUGH EXTERIOR WALLS IN AN APPROVED MANNER
- D. DEMOLITION
- 1. CONTRACTOR SHALL OBTAIN ALL REQUIRED PERMITS BEFORE ANY WORK IS BEGUN. 2. ALL EXITS SHALL BE KEPT READILY ACCESSIBLE AND UNOBSTRUCTED AT ALL TIMES.
- 3. ALL WASTE AND DEBRIS SHALL BE REMOVED IN APPROVED CONTAINERS ON A DAILY BASIS.
- 4. ALL EXISTING PLUMBING FIXTURES NO LONGER IN USE SHALL BE REMOVED WITH ASSOCIATED PIPING. PLUG AND CAP AT SOURCE ALL UNUSED PIPING.
- REMOVE UNUSED WASTE PIPING AND PATCH FLOOR PENETRATION AS REQUIRED.
- 6. ALL PIPING THROUGH SLAB SHALL BE CUT AND CAPPED BELOW FLOOR. REFER TO ARCHITECTURAL DRAWINGS FOR PATCHING OF SLAB TO MATCH EXISTING.
- 7. ALL EXISTING BASE BUILDING UTILITIES, RISERS AND ALL SHAFTS SHALL REMAIN UNLESS OTHERWISE NOTED.
- 8. EXISTING RAIN WATER LINE TO EXISTING TANK SHALL REMAIN.
- LOCATION OF DRAINS AND PIPING ARE APPROXIMATE. CONTRACTOR WILL VERIFY IN FIELD.
- 10. REMOVAL OF ALL EXISTING PIPING BEING ABANDONED SHALL COMPLY TO LOCAL AND STATE BUILDING CODE AS TO ELIMINATE THE POSSIBILITY OF FUTURE BREAKS AND UNNECESSARY INTERFERENCES IN HUNG CEILINGS.
- 11. WHERE EQUIPMENT OR PIPING IS TO BE REMOVED, CONTRACTOR SHALL REMOVE ALL COLLATERAL SUPPORTS, HANGERS AND APPURTENANCES.
- 12. CARE MUST BE TAKEN WHERE SLAB AND CEILINGS ARE TO BE DEMOLISHED TO PROTECT AND PROVIDE SUPPORT FOR ANY EXISTING EQUIPMENT OF PIPING WHICH IS TO REMAIN. (VERIFY IN FIELD)
- 13. ALL REMOVED ITEMS THAT ARE NOT BEING REUSED AND ALL EXCESS MATERIAL AND EQUIPMENT NOT DESIRED BY THE OWNER SHALL BE IMMEDIATELY MOVED FROM THE SITE BY THIS CONTRACTOR.
- 14. THE CONTRACTOR SHALL COORDINATE THE DEMOLITION WORK WITH THE OWNER AND OTHER TRADES.
- 15. PROTECT ALL EXISTING SOIL, WASTE, VENT AND WATER PIPES THAT ARE TO BE REUSED UPON COMPLETION OF DEMOLITION
- 16. CONTRACTOR SHALL PATCH AND REPAIR ALL FLOOR AND WALL OPENINGS TO MATCH EXISTING UPON COMPLETION OF PLUMBING DEMOLITION WORK.
- 17. ALL PLUMBING ROUGH INS WHICH ARE TO BE REMOVED MUST HAVE WATER SUPPLY SHUT OFF PRIOR TO DISCONNECTING AND REMOVING TO PREVENT FLOODING IN THE EVENT THAT PIPES ARE DAMAGED DURING DEMOLITION.
- 18. THE CONTRACTOR SHALL GIVE AMPLE WRITTEN NOTICE IN ADVANCE TO THE OWNER OF ANY REQUIRED SHUTDOWNS OF BUILDING SERVICES.
- e. equipment
- 1. INVESTIGATE PATH THROUGH WHICH EQUIPMENT WILL BE MOVED. ASCERTAIN FROM BUILDING MANAGEMENT WHAT TIMES OF DAY EQUIPMENT MAY BE MOVED.
- 2. ALL EQUIPMENT SHALL BE INSTALLED IN FULL COMPLIANCE WITH THE MANUFACTURER'S INSTALLATION INSTRUCTIONS.
- 3. INSTALL EQUIPMENT AS TO BE READILY ACCESSIBLE FOR OPERATION, MAINTENANCE AND REPAIR. MINOR DEVIATIONS FROM DRAWINGS MAY BE REQUIRED TO ACCOMPLISH THIS.
- F. PIPING
- 1. EXISTING SANITARY / DOMESTIC PIPING TO BE CHECK & CONFIRM IF CAST IRON / GALVANIZED OR PVC. IF CAST IRON OR GALVANIZED, CHANGE TO PVC / CPVC. PIPING SYSTEMS SHALL BE CLEANED, PRESSURED / VACUUM / LEAK TESTED.

### 169 SOUTH ROAD, DEVONSHIRE, BM

- WHERE PIPING CONNECTIONS FOR FIXTURES DIFFER FROM THE LINE SIZE PIPING, IT SHALL BE RESPONSIBILITY OF THE PLUMBING CONTRACTOR TO FURNISH AND INSTALL THE NECESSARY REDUCER/EXPANDER FITTINGS TO ENABLE CONNECTION BETWEEN THE PIPING SYSTEM AND EQUIPMENT.
- PROVIDE DIELECTRIC FITTINGS BETWEEN TWO DISSIMILAR METALS.
- WATER HAMMER ARRESTOR CONFORMED TO ASSE 1010 SHALL BE INSTALLED WHERE QUICK-CLOSING DEVICES ARE UTILIZED.
- WATER DISTRIBUTION PIPING AND FITTINGS SHALL CONFORM TO NSF 61 AND HAVE A PRESSURE RATING OF 150 PSI MINIMUM.
- 6. ALL VALVES SHALL BE OF AN APPROVED TYPE AND MATERIAL COMPATIBLE WITH THE SYSTEM PIPING TYPE. ALL VALVES INTENDED TO SUPPLY POTABLE WATER SHALL MEET THE REQUIREMENTS OF NSF 61.
- PVC PIPING SHALL NOT BE RUN THROUGH FIRE RATED WALLS OR USED IN RETURN AIR PLENUMS.
- CLEANOUTS SHALL BE PROVIDED AS REQUIRED BY APPLICABLE CODES. CLEANOUTS IN DRAINAGE LINES SHALL BE INSTALLED IN THE FOLLOWING LOCATIONS: AT THE BOTTOM OF EACH FIXTURE TRAP WHICH IS NOT INTEGRAL WITH THE 8.1.
- FIXTURE 8.2. AT THE END OF EACH BRANCH DRAINAGE LINE
- AT EACH POINT WHERE DRAINAGE LINES CHANGE DIRECTIONS 8.3.
- 8.4. AT THE FOOT OF EACH INSIDE RISING SOIL OR WASTE LINE
- IN EVERY HORIZONTAL LINE AT NOT MORE THAN FIFTY (50) FEET ON CENTER. 8.5. 9. ALL HOT WATER SUPPLY & RETURN PIPING REQUIRES  $\frac{3}{4}$ " WALL ARM-A-FLEX
- INSULATION.
- 10. ALL PIPING SANITARY, WASTE, VENT, DOMESTIC HOT OR COLD THAT IS RUN THROUGH EXISTING TRANSFORMER AREAS, TO BE INSTALLED WITH FIREMASTER 3M OR EQUIVALENT (FIRE RATED INSULATION).
- G. TESTING & COMMISSIONING
- 1. CONTRACTOR TO VERIFY OPERATING PRESSURES OF EXISTING DOMESTIC WATER SYSTEM.
- 2. PRESSURE TEST NEW DOMESTIC WATER PIPING (HOT WATER AND COLD WATER), AND SUBMIT PRESSURE TEST REPORT FOR THE ENGINEER'S RECORD. PRESSURE TEST SHALL BE PERFORMED AT 1.5 TIMES THE WORKING WATER PRESSURE FOR A PERIOD OF 3 HOURS MINIMUM
- 3. TEST ALL WASTE, SANITARY AND VENT SYSTEMS WITH A MINIMUM OF TEN (10) FEET HEAD OF WATER. PIPING SHALL BE TIGHT AND LEAK FREE AT ALL POINTS.
- 4. TEST ALL PIPING SYSTEMS VALVES FOR FULLY LEAK-TIGHT CLOSURE WHEN SUBJECTED TO NORMAL OPERATING PRESSURES.
- 5. ALL CONCEALED PIPING SHALL BE TESTED BEFORE CLOSING CEILING CONSTRUCTION.
- 6. TEST EQUIPMENT CONTROLS, INCLUDING HOT WATER HEATER CONTROLLER, LEAK ALARMS, AND VERIFICATION OF REMOTE CONTROL & MONITORING POINTS AT EXISTING BUILDING MANAGEMENT SYSTEM.
- 7. CONTRACTOR SHALL SUBMIT ALL START-UP, TESTING, AND COMMISSIONING REPORTS FOR THE ENGINEER'S REVIEW.
- H. TAGS, CHARTS AND NAMEPLATES
- 1. CONTRACTOR SHALL PROPERLY IDENTIFY AND LABEL EACH VALVE, CONTROL, MOTOR, FAN AND PIECE OF APPARATUS IDENTIFIED ON THE PLUMBING DRAWINGS.
- EACH VALVE SHALL HAVE A BRASS TAG WITH IDENTIFYING NUMBER. TAG SHALL BE SECURED TO VALVE STEM WITH A SUFFICIENT LENGTH OF COPPER COATED JACK CHAIN TO ALLOW TAG TO BE EASILY READ. CONTRACTOR SHALL INCLUDE A VALVE IDENTIFICATION CHART IN THEIR SUBMITTAL PACKAGE.
- 3. ALL NAMEPLATES AND LABELS SHALL IDENTIFY COMPONENTS BY PROPER NOMENCLATURE AND NUMBERED ACCORDING TO THE EQUIPMENT SCHEDULES.
- I. SUBMITTALS / SHOP DRAWINGS
- 1. THE CONTRACTOR SHALL SUBMIT SHOP DRAWINGS FOR THE FOLLOWING:
- 1.1. PIPIG FIXTURES, SUPPORTS AND TRIM 1.2. VALVES
- 1.3. PIPE INSULATION
- 1.4. BACKFLOW PREVENTORS
- ELECTRIC CONTROLS 15 WATER HAMMER ARRESTORS 16
- HANGERS AND SUPPORTS 1.7.
- TRAP PRIMERS 1.8.
- 1.9. ACCESS DOORS AND CLEAN-OUT PLATES

F	PLUMBING DRA
DWG No.	
P-001	PLUMBING COVER PAGE
P-400	PLUMBING SITE PLAN
P-401	PLUMBING BELOW GRAD

SYM	BOLS & ABB
ABBREVIATIONS	
$\bowtie$	BALL VALVE
R	ACTUATED BALL V
	BACKWATER VALVE
$\bigcirc$	PUMP
NO.	NO. NUMBER
PD	PRESSURE DROP
PSI	POUNDS PER SQUA
PSIG	PSI GAUGE
(R)	RELOCATE
Ν	NEW

#### WING LIST

DESCRIPTION

ADE PLAN & SCHEDULE

#### REVIATIONS DESCRIPTION

/ALVE

JARE INCH

### THE MINISTRY OF PUBLIC WORKS P.O. Box HM525 Hamilton HMCX Bermuda Phone: (441) 295-5151

### DEPARTMENT OF WORKS AND ENGINEERING

Fax: (441) 295-5658

#### ENGINEER:



ENGINEERING SERVICES 25 Serpentine Road, Pembroke HM 07 Phone: (441) 294-3693 Email: info@iepc.bm www.iepc.bm

#### ISSUED FOR: TENDER

AMENDMENTS

NO	REVISION	BY	APP	DATE
Α	FOR TENDER	CF	_	14/06/24

SCALE: AS SHOWN AT ANSI D

SURVEY PREPARED BY: 	DATE: —
DESIGN	
PREPARED BY:	DATE:
D.CABRAL	22/07/24
CHECKED BY:	DATE:
ZJ	22/07/24
DRAWING	
PREPARED BY:	DATE:
D.CABRAL	22/07/24
CHECKED BY:	DATE:
ZJ	22/07/24
APPROVED BY:	DATE:
ZJ	22/07/24
PROJECT NUMBER:	

PROJECT NAME:

09010030

### BOTANICAL GARDENS CACTI HOUSE MECHANICAL DESIGN 2024

SHEET TITLE:

## COVER PAGE

SHEET NUMBER:

REVISION

Α

### M100

## PLUMBING NOTES

#### A. BERMUDA DEPARTMENT OF PLANNING NOTES

- 1. ALL WORK SHALL COMPLY WITH APPLICABLE SECTIONS OF ALL LOCAL CODES AND AMENDMENTS TO DATE, INCLUDING BUT NOT LIMITED TO THE FOLLOWING:
- a. BERMUDA BUILDING CODE 2014 (ADOPTED FROM IBC 2012)
- b. BERMUDA MECHANICAL CODE 2014 (ADOPTED FROM IMC 2012)
- c. BERMUDA ELECTRICAL CODE 2014 (ADOPTED FROM NEC 2011) d. BERMUDA PLUMBING CODE 2014 (ADOPTED FROM IPC 2012)
- e. BERMUDA ENERGY CONSERVATION CODE 2014 (ADOPTED FROM IECC 2012)
- c. BERMUDA FIRE CODE 2014 (ADOPTED FROM NFPA STANDARDS)
- 2. ALL WORK SHALL COMPLY WITH THE REQUIREMENTS OF OF ALL APPLICABLE REFERENCE STANDARDS, INCLUDING BUT NOT LIMITED TO THE FOLLOWING: a. ANSI
- b. ASPE
- c. ASHRAE STANDARD 90.1: ENERGY STANDARD FOR BUILDINGS
- 3. ALL WORK SHALL BE SUBJECT TO SPECIAL INSPECTIONS AS APPLICABLE: a. WIND RESISTANCE (IBC SECTION 1705.10)
- b. SPRAYED FIRE-RESISTANT MATERIALS (IBC SECTION 1705.13) c. MASTIC AND INTUMESCENT FIRE RATED COATINGS (IBC SECTION
- 1705.14)
- d. FIRE RESISTANT PENETRATION AND JOINTS (IBC SECTION 1705.16)
- e. ENERGY CODE INSPECTIONS
- 4. ALL WORK SHALL COMPLY WITH THE GOVERNMENT OF BERMUDA LAWS AND REGULATIONS, INCLUDING BUT NOT LIMITED TO: a. BERMUDA PUBLIC HEALTH ACT 1949
- b. BERMUDA OCCUPATIONAL SAFETY & HEALTH REGULATIONS 2009
- B. OCCUPATIONAL HEALTH. SAFETY AND ENVIRONMENT (OHSE) REQUIREMENTS
- 5. THE CONTRACTOR SHALL PROVIDE DIRECT SUPERVISION OVER THEIR WORKFORCE ON SITE, AND ENSURE THEIR WORK CONFORMS TO OHSE POLICIES.
- 6. THE CONTRACTOR SHALL SUPPLY AND UTILIZE THE APPROPRIATE PERSONAL PROTECTION EQUIPMENT (PPE) FOR ALL WORKS.
- 7. THE CONTRACTOR SHALL OBTAIN ALL NECESSARY AND APPLICABLE PERMITS OR APPROVALS.
- 8. THE CONTRACTOR SHALL ELIMINATE OR CONTROL ALL SAFETY HAZARDS AND POTENTIAL ENVIRONMENTAL IMPACTS ASSOCIATED WITH THE PROJECT.
- C. GENERAL NOTES
- REMOVAL AND RELOCATION OF CERTAIN EXISTING WORK WILL BE NECESSARY FOR THE PERFORMANCE OF THE WORK. EXISTING CONDITIONS ARE NOT COMPLETELY DETAILED ON THE DRAWINGS, CONTRACTOR SHALL SURVEY THE SITE AND INCLUDE ALLOWANCE FOR SUCH REMOVALS AND RELOCATIONS.
- 2. WORK SHALL BE DONE WHEN AND AS DIRECTED AND SHALL BE PERFORMED SO AS TO CAUSE THE LEAST POSSIBLE INCONVENIENCE AND DISTURBANCE TO THE SURROUNDING POPULATION. PLAN INSTALLATION OF NEW WORK AND CONNECTIONS TO EXISTING WORK TO AVOID INTERFERENCE WITH REGULAR OPERATION OF EXISTING FACILITIES.
- 3. MATERIALS. DOCUMENTATION AND WORKMANSHIP SHALL BE IN ACCORDANCE WITH LOCAL CODES, REFERENCE STANDARDS, AND AS SPECIFIED.
- DISCONNECT, REMOVE AND/OR RELOCATE EXISTING MATERIALS, EQUIPMENT AND OTHER WORK AS NOTED OR REQUIRED FOR PROPER INSTALLATION OF NEW WORK.
- FIREPROOFING AND INSULATION DISTURBED BY NEW CONSTRUCTION SHALL BE RESTORED TO ORIGINAL CONDITION.
- SUPPORT ALL PIPING AND/OR EQUIPMENT FROM BUILDING STRUCTURE, FLOORS, AND BURIED IN TRENCH IN AN APPROVED MANNER. WHERE OVERHEAD CONSTRUCTION DOES NOT PERMIT FASTENING OF SUPPORTS FOR EQUIPMENT, FURNISH ADDITIONAL FRAMING.
- 7. SEAL OPENINGS AROUND PIPING THROUGH WALLS AND FOUNDATION SLABS IN AN APPROVED MANNER USING MINERAL WOOL OR OTHER NON-COMBUSTIBLE MATERIAL. ALL PENETRATIONS SHALL BE FIRE-PROOFED, AS REQUIRED.
- CONTRACTOR TO PROVIDE FULLY COORDINATED SHOP DRAWINGS AND SUBMITTALS FOR THE ENGINEER'S REVIEW PRIOR TO PROCUREMENT, FABRICATION, OR INSTALLATION OF NEW WORK.
- 9. CONTRACTOR SHALL USE EXTREME CAUTION WHEN INSTALLING FIXTURES OR PIPING ON OR IN FINISHED WALLS AND PARTITIONS.
- 10. PROVIDE ANGLE STOPS ON WATER PIPING AT ALL FIXTURES.
- 11. CONTRACTOR SHALL VERIFY EXACT LOCATION OF EXISTING PIPING IN FIELD BEFORE ANY INSTALLATION OF NEW WORK.
- 12. FOR EXACT LOCATION OF PLUMBING FIXTURES, REFER TO ARCHITECTURAL DRAWINGS.
- 13. ALL PLUMBING WORK SHALL COMPLY WITH BUILDING STANDARDS AND REQUIREMENTS.
- 14. ALL NEW PLUMBING FIXTURES SHALL COMPLY WITH WATER CONSERVATION LAWS.
- 15. ALL FIXTURES SHALL BE AS SPECIFIED BY ARCHITECT, FURNISHED AND INSTALLED BY PLUMBING CONTRACTOR.
- 16. CONTRACTOR SHALL PROVIDE TRAP PRIMERS FOR ALL FLOOR DRAINS
- 17. CONTRACTOR SHALL PROVIDE ACCESS DOORS TO ALL DOMESTIC WATER VALVES AND TRAP PRIMERS.
- 18. CONTRACTOR SHALL PROVIDE WATER HAMMER ARRESTORS ON ALL QUICK CLOSING FIXTURES.
- 19. CONTRACTOR TO FIRE PROOF AND SEAL ALL PENETRATIONS THROUGH EXTERIOR WALLS IN AN APPROVED MANNER.


- D. DEMOLITION
- CONTRACTOR SHALL OBTAIN ALL REQUIRED PERMITS BEFORE ANY WORK IS BEGUN.
- ALL EXITS SHALL BE KEPT READILY ACCESSIBLE AND UNOBSTRUCTED AT ALL TIMES.
- 3. ALL WASTE AND DEBRIS SHALL BE REMOVED IN APPROVED CONTAINERS ON A DAILY BASIS.
- 4. ALL EXISTING PLUMBING FIXTURES NO LONGER IN USE SHALL BE REMOVED WITH ASSOCIATED PIPING. PLUG AND CAP AT SOURCE ALL UNUSED PIPING.
- 5. REMOVE UNUSED WASTE PIPING AND PATCH FLOOR PENETRATION AS REQUIRED
- 6. ALL PIPING THROUGH SLAB SHALL BE CUT AND CAPPED BELOW FLOOR. REFER TO ARCHITECTURAL DRAWINGS FOR PATCHING OF SLAB TO MATCH EXISTING.
- 7. ALL EXISTING BASE BUILDING UTILITIES, RISERS AND ALL SHAFTS SHALL REMAIN UNLESS OTHERWISE NOTED.
- 8. EXISTING RAIN WATER LINE TO EXISTING TANK SHALL REMAIN.
- 9. LOCATION OF DRAINS AND PIPING ARE APPROXIMATE. CONTRACTOR WILL VERIFY IN FIELD.
- 10. REMOVAL OF ALL EXISTING PIPING BEING ABANDONED SHALL COMPLY TO LOCAL AND STATE BUILDING CODE AS TO ELIMINATE THE POSSIBILITY OF FUTURE BREAKS AND UNNECESSARY INTERFERENCES IN HUNG CEILINGS.
- 11. WHERE EQUIPMENT OR PIPING IS TO BE REMOVED, CONTRACTOR SHALL REMOVE ALL COLLATERAL SUPPORTS, HANGERS AND APPURTENANCES.
- 12. CARE MUST BE TAKEN WHERE SLAB AND CEILINGS ARE TO BE DEMOLISHED TO PROTECT AND PROVIDE SUPPORT FOR ANY EXISTING EQUIPMENT OF PIPING WHICH IS TO REMAIN. (VERIFY IN FIELD)
- 13. ALL REMOVED ITEMS THAT ARE NOT BEING REUSED AND ALL EXCESS MATERIAL AND EQUIPMENT NOT DESIRED BY THE OWNER SHALL BE IMMEDIATELY MOVED FROM THE SITE BY THIS CONTRACTOR.
- 14. THE CONTRACTOR SHALL COORDINATE THE DEMOLITION WORK WITH THE OWNER AND OTHER TRADES.
- 15. PROTECT ALL EXISTING SOIL, WASTE, VENT AND WATER PIPES THAT ARE TO BE REUSED UPON COMPLETION OF DEMOLITION
- 16. CONTRACTOR SHALL PATCH AND REPAIR ALL FLOOR AND WALL OPENINGS TO MATCH EXISTING UPON COMPLETION OF PLUMBING DEMOLITION WORK.
- 17. ALL PLUMBING ROUGH INS WHICH ARE TO BE REMOVED MUST HAVE WATER SUPPLY SHUT OFF PRIOR TO DISCONNECTING AND REMOVING TO PREVENT FLOODING IN THE EVENT THAT PIPES ARE DAMAGED DURING DEMOLITION.
- 18. THE CONTRACTOR SHALL GIVE AMPLE WRITTEN NOTICE IN ADVANCE TO THE OWNER OF ANY REQUIRED SHUTDOWNS OF BUILDING SERVICES.
- E. EQUIPMENT
- 1. INVESTIGATE PATH THROUGH WHICH EQUIPMENT WILL BE MOVED. ASCERTAIN FROM BUILDING MANAGEMENT WHAT TIMES OF DAY EQUIPMENT MAY BE MOVED.
- 2. ALL EQUIPMENT SHALL BE INSTALLED IN FULL COMPLIANCE WITH THE MANUFACTURER'S INSTALLATION INSTRUCTIONS.
- 3. INSTALL EQUIPMENT AS TO BE READILY ACCESSIBLE FOR OPERATION, MAINTENANCE AND REPAIR. MINOR DEVIATIONS FROM DRAWINGS MAY BE REQUIRED TO ACCOMPLISH THIS.


#### F. PIPING

- 1. PIPING SYSTEMS SHALL BE CLEANED, VACUUM / LEAK TESTED.
- 2. WHERE PIPING CONNECTIONS FOR FIXTURES DIFFER FROM THE LINE SIZE PIPING, IT SHALL BE RESPONSIBILITY OF THE PLUMBING CONTRACTOR TO FURNISH AND INSTALL THE NECESSARY REDUCER/EXPANDER FITTINGS TO ENABLE CONNECTION BETWEEN THE PIPING SYSTEM AND EQUIPMENT.
- 3. PROVIDE DIELECTRIC FITTINGS BETWEEN TWO DISSIMILAR METALS.
- 4. WATER HAMMER ARRESTOR CONFORMED TO ASSE 1010 SHALL BE INSTALLED WHERE QUICK-CLOSING DEVICES ARE UTILIZED.
- 5. WATER DISTRIBUTION PIPING AND FITTINGS SHALL CONFORM TO NSF 61 AND HAVE A PRESSURE RATING OF 150 PSI MINIMUM.
- 6. ALL VALVES SHALL BE OF AN APPROVED TYPE AND MATERIAL COMPATIBLE WITH THE SYSTEM PIPING TYPE. ALL VALVES INTENDED TO SUPPLY POTABLE WATER SHALL MEET THE REQUIREMENTS OF NSF 61.
- 7. PVC PIPING SHALL NOT BE RUN THROUGH FIRE RATED WALLS OR USED IN RETURN AIR PLENUMS.
- 8. CLEANOUTS SHALL BE PROVIDED AS REQUIRED BY APPLICABLE CODES. CLEANOUTS IN DRAINAGE LINES SHALL BE INSTALLED IN THE FOLLOWING LOCATIONS:
- AT THE BOTTOM OF EACH FIXTURE TRAP WHICH IS NOT INTEGRAL WITH THE 8.1. FIXTURE
- AT THE END OF EACH BRANCH DRAINAGE LINE 8.2.
- AT EACH POINT WHERE DRAINAGE LINES CHANGE DIRECTIONS 8.3. 8.4. AT THE FOOT OF EACH INSIDE RISING SOIL OR WASTE LINE
- IN EVERY HORIZONTAL LINE AT NOT MORE THAN FIFTY (50) FEET ON CENTER. 8.5.
- G. TESTING & COMMISSIONING
- 1. CONTRACTOR TO VERIFY OPERATING PRESSURES OF EXISTING DOMESTIC WATER SYSTEM.
- 2. GENERAL CONTRACTOR TO RETROACTIVELY COMMISSION EXISTING DOMESTIC WATER BOOSTER SYSTEM AND VERIFY AND ADJUST THE OPERATING PRESSURES OF THE SYSTEM.
- 3. PRESSURE TEST NEW DOMESTIC WATER PIPING (HOT WATER AND COLD WATER), AND SUBMIT PRESSURE TEST REPORT FOR THE ENGINEER'S RECORD.

	PRESSURE TEST SHALL BE PERFORMED AT 1.5 TIMES THE WORKING WATER PRESSURE FOR A PERIOD OF 3 HOURS MINIMUM.	Р	LUMBING DRAWING LIST
4.	TEST ALL WASTE, SANITARY AND VENT SYSTEMS WITH A MINIMUM OF TEN (10) FEET HEAD OF WATER. PIPING SHALL BE TIGHT AND LEAK FREE AT ALL POINTS.	DWG No.	DESCRIPTION
5.	TEST ALL PIPING SYSTEMS VALVES FOR FULLY LEAK-TIGHT CLOSURE WHEN SUBJECTED TO NORMAL OPERATING PRESSURES.	P-001	PLUMBING COVER PAGE
6.	ALL CONCEALED PIPING SHALL BE TESTED BEFORE CLOSING CEILING CONSTRUCTION.	P-400	PLUMBING DRAWINGS
	TEST EQUIPMENT CONTROLS, INCLUDING HOT WATER HEATER CONTROLLER, LEAK ALARMS, AND VERIFICATION OF REMOTE CONTROL & MONITORING POINTS AT EXISTING BUILDING MANAGEMENT SYSTEM.		ABBREVIATIONS
8.	CONTRACTOR SHALL SUBMIT ALL START-UP, TESTING, AND COMMISSIONING REPORTS FOR THE ENGINEER'S REVIEW.	ABBREVIATIONS	DESCRIPTION
H. TAC	GS, CHARTS AND NAMEPLATES	CW	COLD WATER PIPING
	CONTRACTOR SHALL PROPERLY IDENTIFY AND LABEL EACH VALVE, CONTROL, MOTOR,	HW	HOT WATER PIPING
1.	FAN AND PIECE OF APPARATUS IDENTIFIED ON THE PLUMBING DRAWINGS.	HWH	HOT WATER HEATER
2.	EACH VALVE SHALL HAVE A BRASS TAG WITH IDENTIFYING NUMBER. TAG	(N)	NEW
	SHALL BE SECURED TO VALVE STEM WITH A SUFFICIENT LENGTH OF COPPER COATED JACK CHAIN TO ALLOW TAG TO BE EASILY READ. CONTRACTOR	NO.	NO. NUMBER
	SHALL INCLUDE A VALVE IDENTIFICATION CHART IN THEIR SUBMITTAL PACKAGE.	PD	PRESSURE DROP
3	ALL NAMEPLATES AND LABELS SHALL IDENTIFY COMPONENTS BY PROPER	PSI	POUNDS PER SQUARE INCH
	NOMENCLATURE AND NUMBERED ACCORDING TO THE EQUIPMENT	PSIG	PSI GAUGE
	SCHEDULES.	(R)	RELOCATE
I. SUE	BMITTALS / SHOP DRAWINGS	S	SANITARY PIPING
1. 1.1	THE CONTRACTOR SHALL SUBMIT SHOP DRAWINGS FOR THE FOLLOWING: . PLUMBING FIXTURES, SUPPORTS AND TRIM	SH	SHOWER
1.2	VALVES	SK	SINK
1.3 1.4		V	VENT
1.5 1.6		VB	VACUUM BREAKER
1.7	2. WATER HAMMER ARRESTORS	VTR	VENT THRU ROOF
1.8 1.9		W	WASTE PIPING
1.1	0. ACCESS DOORS AND CLEAN-OUT PLATES	WC	WATER CLOSET

### GUTTER DETAIL - NEW CACTI HOUSE PLUMBING LAYOUT 1:60

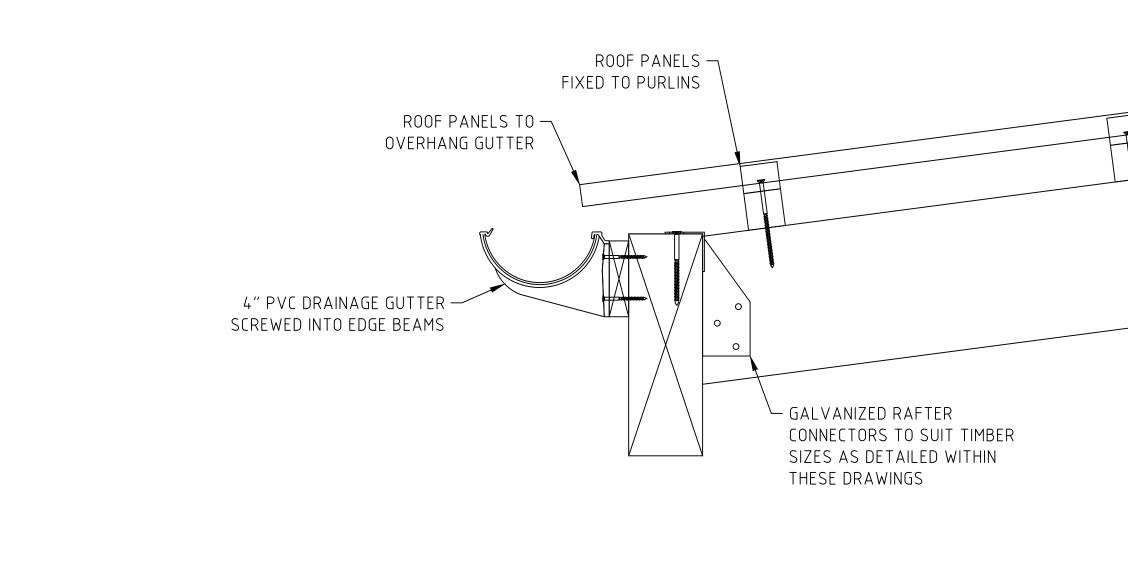

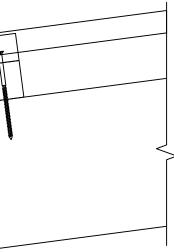

### THE MINISTRY OF PUBLIC WORKS P.O. Box HM525 Hamilton HMCX Bermuda Phone: (441) 295-5151

### DEPARTMENT OF WORKS AND ENGINEERING

Fax: (441) 295-5658

#### ENGINEER:



#### ENGINEERING SERVICES 25 Serpentine Road, Pembroke HM 07 Phone: (441) 294-3693

Email: info@iepc.bm www.iepc.bm

ISSUED FOR: TENDER

#### AMENDMENTS

NO	REVISION	BY	APP	DATE
Α	SUBMITTED FOR REVIEW	CF	_	14/06/24

SCALE: AS SHOWN AT ANSI D

SURVEY	
PREPARED BY:	DATE:
	—
DESIGN	
PREPARED BY:	DATE:
D.CABRAL	22/07/24
CHECKED BY:	DATE:
ZJ	22/07/24
DRAWING	
PREPARED BY:	DATE:
D.CABRAL	14/06/24
CHECKED BY:	DATE:
ZJ	22/07/24
APPROVED BY:	DATE:
ZJ	22/07/24
PROJECT NUMBER:	

PROJECT NAME:

09010030

### BOTANICAL GARDENS CACTI HOUSE MECHANICAL DESIGN 2024

SHEET TITLE:

### PLUMBING NOTES & GUTTER DETAIL

SHEET NUMBER:


REVISION

M200


Α

## NORTH PLAN VIEW - NEW CACTI HOUSE PLUMBING LAYOUT

1:40

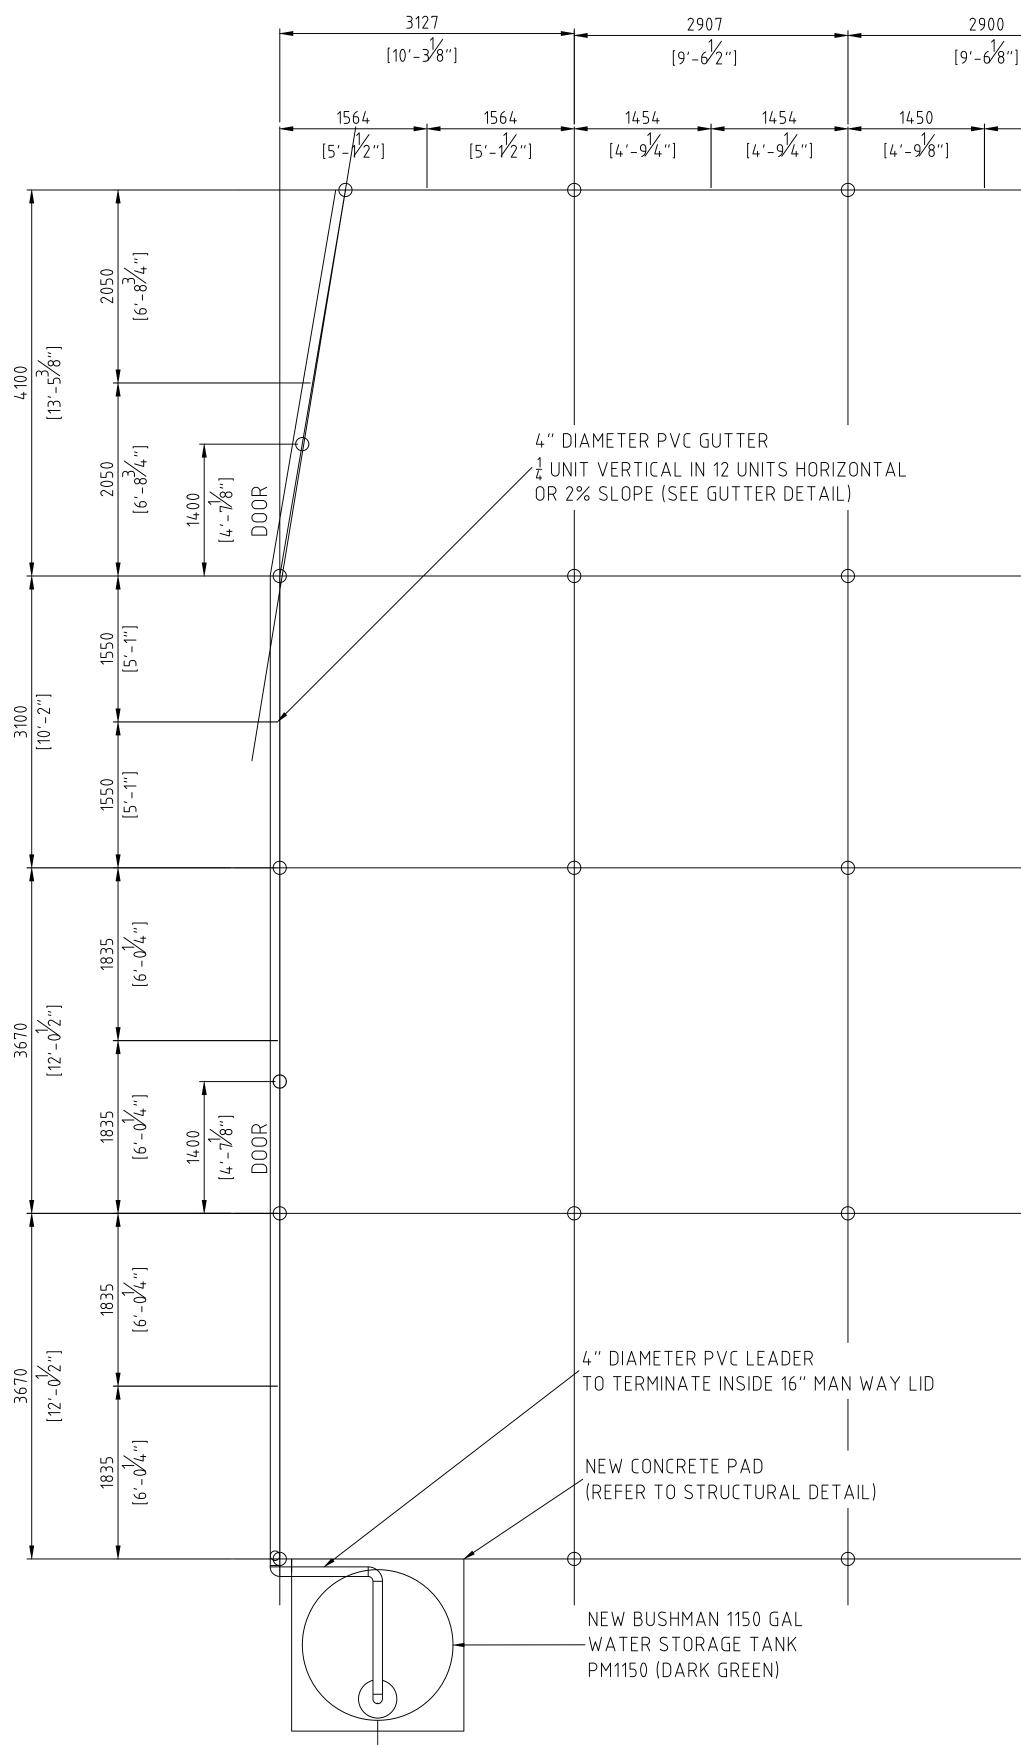


### 2401 3315 3090 3100 [7'-10/2"] [10'-2''] [10'-10'2''] [10'-15/8''] 1545 1658 1550 1201 1450 1545 1550 1658 1201 [5'-5/4"] [3'-114"] [4'-9/8''] [5'-5/4''] [5'-078''] [5'-078''] [5'-1''] [5'-1''] [3'-11/4"] 4" DIAMETER PVC GUTTER LUNIT VERTICAL IN 12 UNITS HORIZONTAL OR 2% SLOPE (SEE GUTTER DETAIL) 4" DIAMETER PVC LEADER 🔨 TO TERMINATE INSIDE 16" MAN WAY LID NEW CONCRETE PAD (REFER TO STRUCTURAL DETAIL) NEW BUSHMAN 1150 GAL WATER STORAGE TANK-PVC LINE TO BE TRENCHED AND PM1150 (DARK GREEN) TIED INTO TANK DISCHARGE VALVES

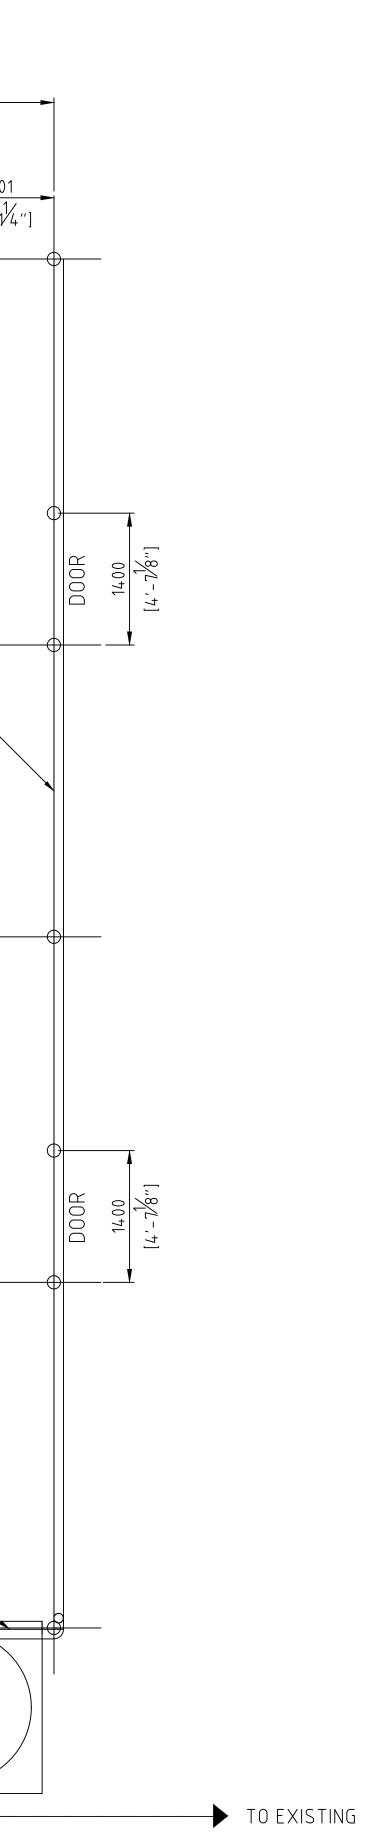

### THE MINISTRY OF PUBLIC WORKS P.O. Box HM525 Hamilton HMCX Bermuda Phone: (441) 295-5151 DEPARTMENT OF WORKS AND ENGINEERING Fax: (441) 295-5658 ENGINEER: **ENGINEERING SERVICES** 25 Serpentine Road, Pembroke HM 07 Phone: (441) 294-3693 Email: info@iepc.bm www.iepc.bm ISSUED FOR: TENDER AMENDMENTS: NO | REVISION | BY |APP| DATE A FOR TENDER CF – 14/06/24 SCALE: AS SHOWN AT ANSI D SURVEY PREPARED BY: DATE: _ _ DESIGN DATE: 14/06/24 PREPARED BY: D.CABRAL DATE: 22/07/24 CHECKED BY: ZJ DRAWING DATE: 14/06/24 PREPARED BY: D.CABRAL DATE: 22/07/24 CHECKED BY: ZJ DATE: 22/07/24 APPROVED BY: ZJ PROJECT NUMBER: 09010030 PROJECT NAME: BOTANICAL GARDENS CACTI HOUSE MECHANICAL DESIGN 2024SHEET TITLE: PLAN VIEWS SHEET NUMBER: REVISION M400А

## NORTH PLAN VIEW - NEW CACTI HOUSE PLUMBING LAYOUT

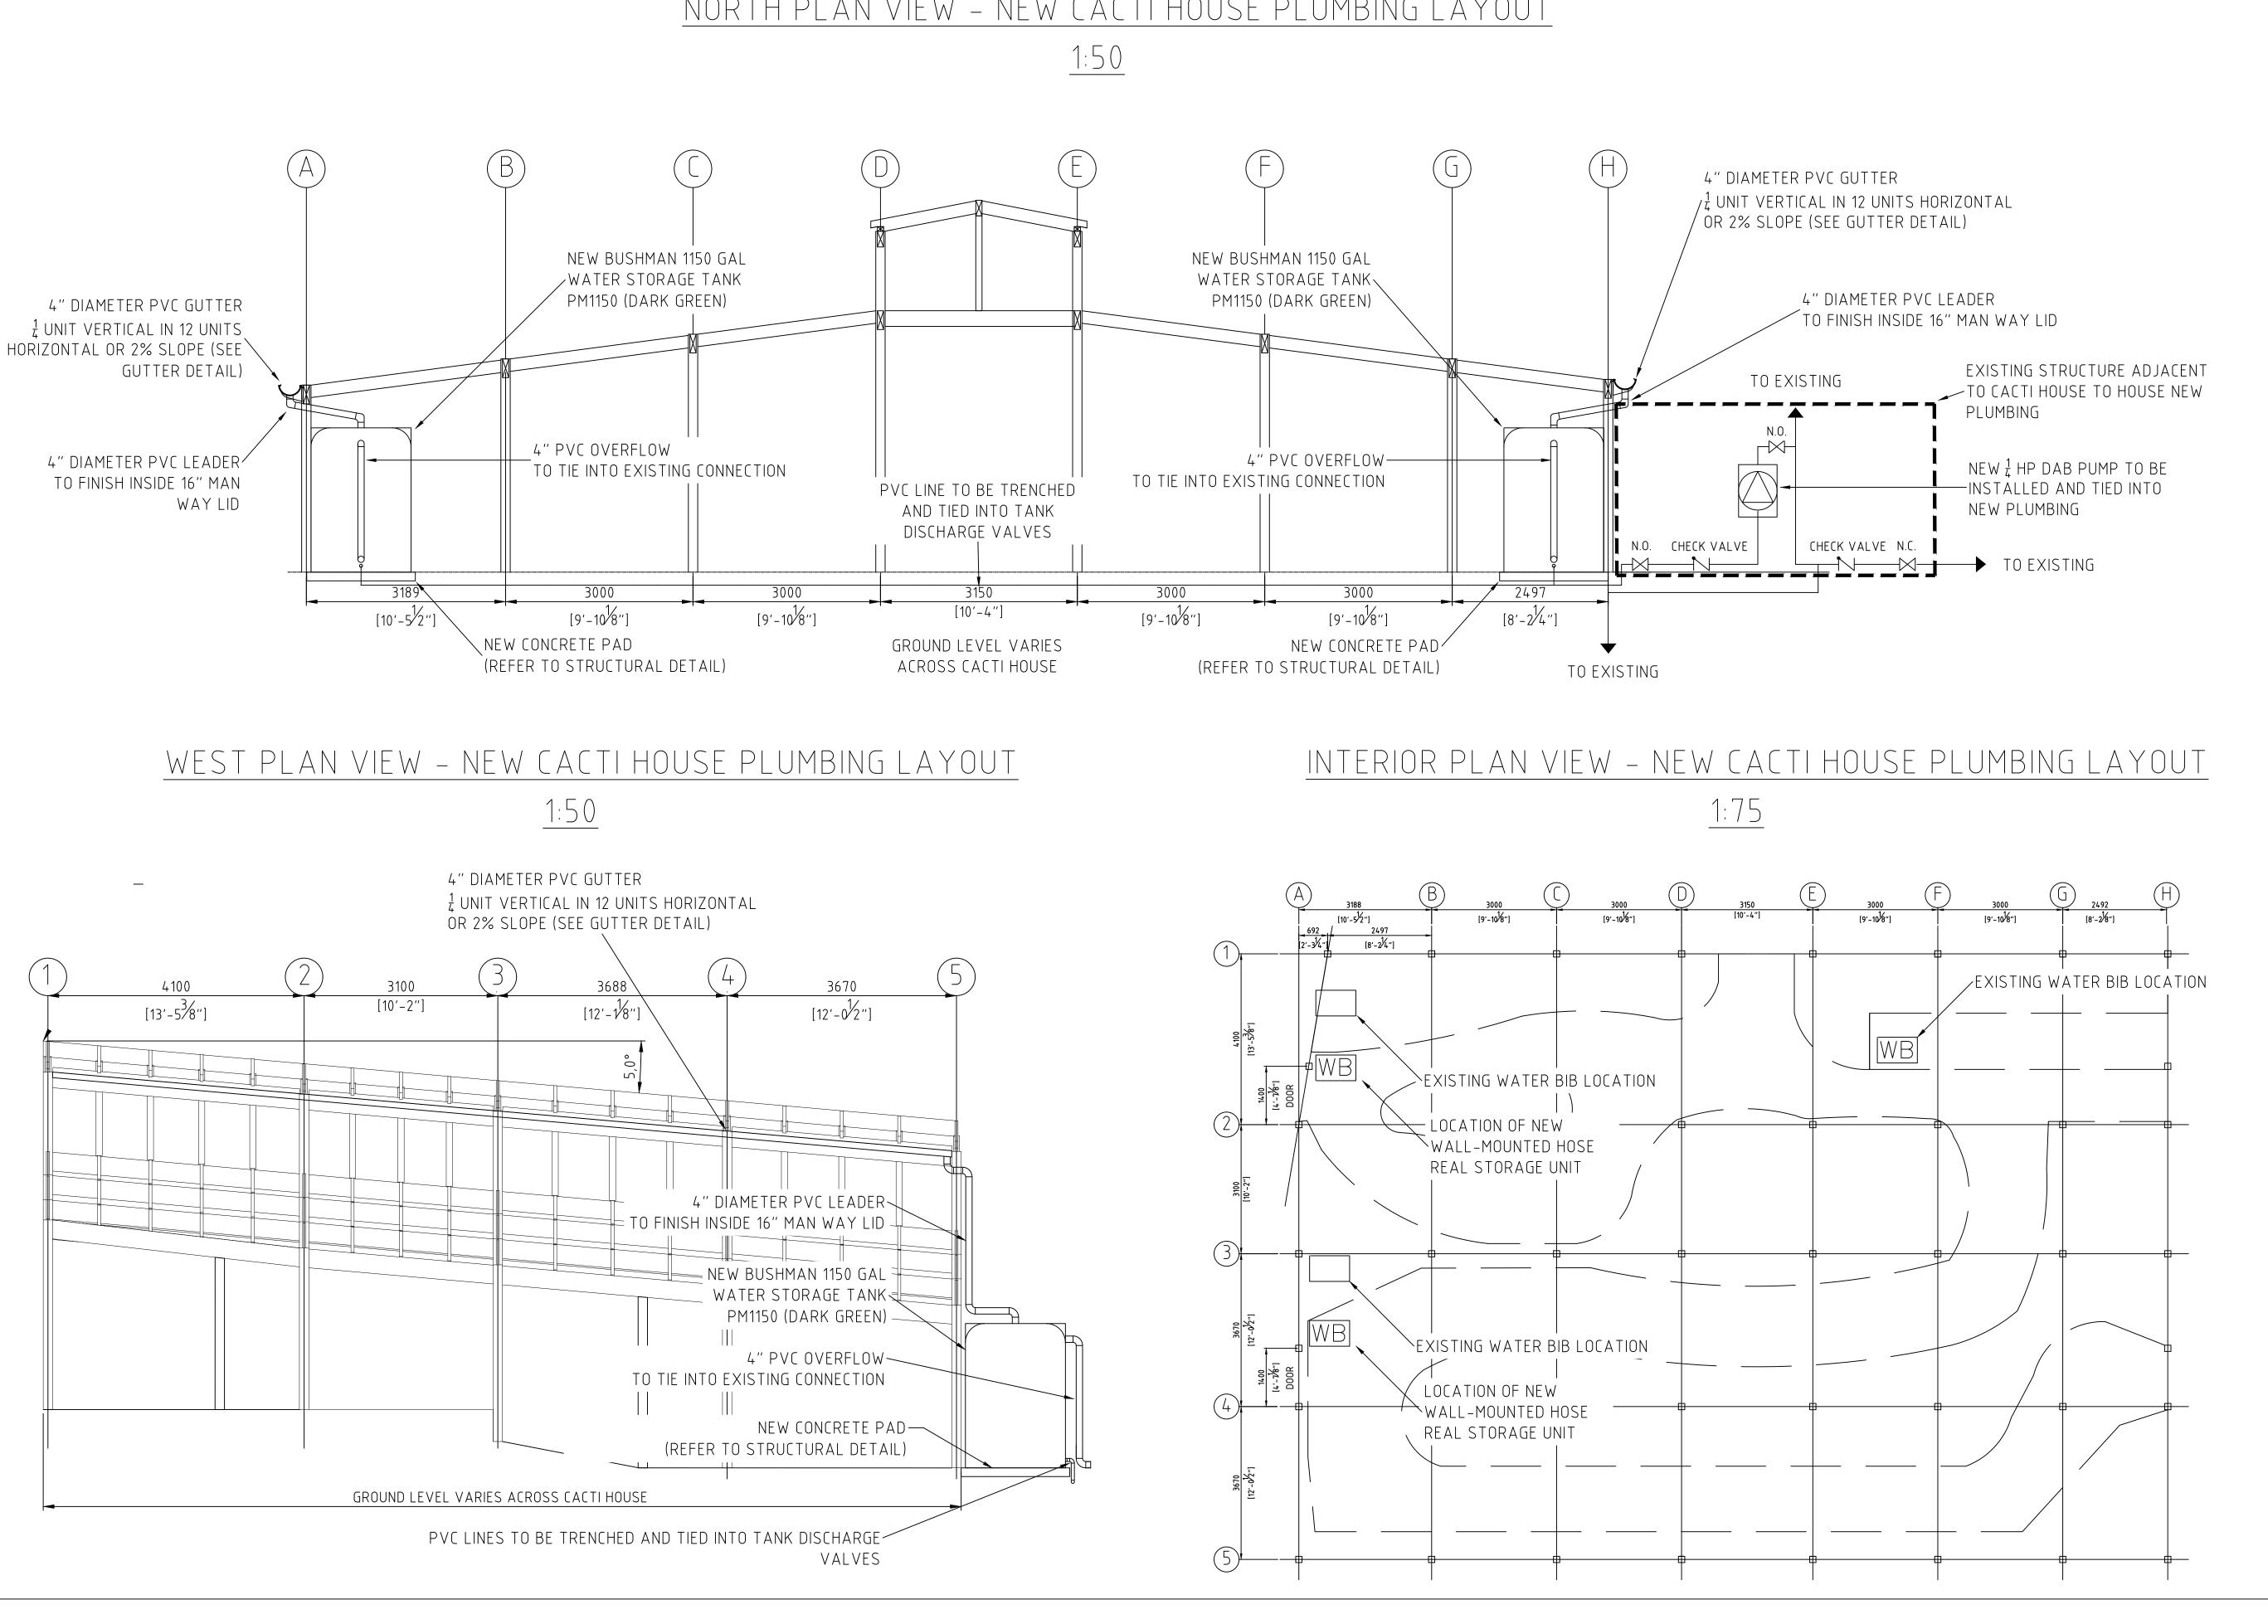



### THE MINISTRY OF PUBLIC WORKS P.O. Box HM525 Hamilton HMCX Bermuda Phone: (441) 295-5151 DEPARTMENT OF WORKS AND ENGINEERING Fax: (441) 295-5658 ENGINEER: **ENGINEERING SERVICES** 25 Serpentine Road, Pembroke HM 07 Phone: (441) 294-3693 Email: info@iepc.bm www.iepc.bm ISSUED FOR: TENDER AMENDMENTS: NO | REVISION | BY |APP| DATE CF – 14/06/24 A FOR TENDER SCALE: AS SHOWN AT ANSI D SURVEY PREPARED BY: DATE: DESIGN PREPARED BY: DATE: 14/06/24 D.CABRAL DATE: 22/07/24 CHECKED BY: ZJ DRAWING DATE: 14/06/24 PREPARED BY: D.CABRAL DATE: 22/07/24 CHECKED BY: ZJ DATE: APPROVED BY: 22/07/24 ZJ PROJECT NUMBER: 09010030 PROJECT NAME: BOTANICAL GARDENS CACTI HOUSE MECHANICAL DESIGN 2024SHEET TITLE: PLAN VIEWS REVISION SHEET NUMBER:

M401

A

		ELECTRICAL SPE	ECIF	ICA	TION	NS	KEY OF	SYME	BOLS	PUBLIC P.O. Box Hamilton HMC Phone: (441)	HM525 X Bermud
CODE), NF WIRING CONTRA CONTRA CON	PA 72 (FII SHALL CO ACTOR SH RING SHITON BY EI ION BUILT IN ION SHALL SHALL ORK SHALL NIDA FIL NIDA BUIL NIDA SHALL SHALL INSTALATION SHALL BE IN COMPLIANE WITH THE REQUIR IRE ALARM CODE), AND MEPA 101 (LIFE SAFETY CODE). COMPLIVITH MEPA 70, WHICH INCLUDE! THE INSTALL OF NE HALL ALOW FOR VOLTAGE DROPS TO INSURE PROPER VOL ALL DE NEW, MOWEVER THE REUSE OF EXISTING WHI ENGINEER OF RECORD. INCESS ESTIVIESS DEAVININGS AND/OR SPECIFICATIONS AND INCESS ESTIVIESS OF ADDITION SOLUTION SOLUTIONS AS FRE CONSTRUCTION SOLUTION SOLUTIONS ON AND TO CONFLIC INAGER IN LAYING OUT OF WORK SO AS NOT TO CONFLIC INAGER IN LAYING OUT OF WORK SOLAS NOT TO CONFLIC INAGER IN LAYING OUT OF WORK SOLAS NOT TO CONFLIC INAGER IN LAYING OUT OF WORK SOLAS NOT TO CONFLIC INAGER IN LAYING OUT OF WORK SOLAS NOT TO CONFLIC INAGER IN LAYING OUT OF WORK SOLAS NOT TO CONFLIC INAGER IN LAYING OUT OF WORK SOLAS NOT TO CONFLIC INAGER IN LAYING OUT OF WORK SOLAS NOT TO CONFLIC INAGER IN LAYING OUT OF WORK SOLAS NOT TO CONFLIC INAGER IN LAYING OUT OF WORK SOLAS NOT TO CONFLIC INGE CONFLICTION SOLADONE ENCE OF AUTOMATIC TRANSFER SWITCH SHALL ME IN CONF DENDER FOR SHALL BE IN COMPLIANCE ON THE REQUIRES INDIVIDUAL OUT OF DENDER SECTIONS OF ALL LAYS, LOCA ILL CORPLY WITH THE BERMUDA RED SHETWING TO FLANNING IN LILIONS CONCERNING ANDOPTED FROM NEC 2011 INDIVIDUAL CODE 2014 (ADOPTED FROM NEC 2011) INDIVIDUAL CODE 2014 (ADOPTED FROM NEC 2011) LICORPLY WITH THE REQUIREMENTS (F OF ALL APPLICABLE DEDORS ILL CORPLY WITH THE REQUIREMENTS (F OF ALL APPLICABLE DEDORS) MAMBEL AND COMBUSTELLE LIDIDS CODE INDIVIDUATION CODE 2014 (ADOPTED FROM NEC 2011) INDIVIDIATION CODE 2014 (ADOPTED FROM NEC 2011) INDIVIDIATION CODE 2014 (ADOPTED FROM NEC 2011) INDIVIDIATION CODE 2014 (ADOPTED FROM NEC 2014 (ADOPTED FROM NEC 2014) INDIVIDIATION CODE 2014 (ADOPTED	EW WFIING TO LTAGE AT ELE RING SHALL I EXISTING CO ENGINEER AS : SHOLL I ENGINEER AS : SHOLL I FILMING WITH WORK WITH WORK WITH WORK WITH WORK MENTS OF NET NOTES. AL CODES AND FROM NEPA S 122 E REFERENCE	DELECTRICA ICTRICAL DE BE ALLOWE NUTTIONS. REQUIRED. K OF OTHER THE REQUI PA 10 ARTIC D AMENDARDS) ITANDARDS) E STANDARD	VEHICLE SHELT MOES. ED BUT SHALL BUT SHALL BUT SHALL CONTRACTOR TRADES LAS REMEMTS OF N LE 445 AND AR NTS TO DATE, J DS, INCLUDING	ER ELEICTRICAL DEVICES L BE INSPECTED BEFOR ERRED TO THE ENGINES SHALLASD COORDAN STLY, CONTRACTOR SHA OFPA 70 JARTICLE 700. TICLE 7'05. NCLUD ING:	OUAD RECEPTACLE OROUND FAULT (OPCI RECEPTACLE PLOOR SURFACE MOINTED DUPLEX RECEPTACLE TELEPHONE OUTLET - WALL MOUNTED DATA OUTLET - WALL VOUNTED TELEPHONEEDATA OUTLET - PLOOR MOUNTED ELECTRICAL PANEL		AUTOMATIC TRANSPER SWITCH ELECTRICAL PANEL METER ELECTRICAL SWITCHGEAR FIRE ALARAY BELL SMOKE DETECTOR HEAT DETECTOR PULL STATION STROBE LIGHT MORN STROBE CONDUIT RUN JUNCTION BOX REMOTE AMAUNCIATOR EXISTING DIRECT CONNECTION	DEPARTME WORKS AND EN Fax: (441) 2 INTERN DEPARTMENT INTERN ENGINEERING Service Pack Arriver and Comparison of the Comparison Service Pack Arriver and Pack of the Comparison Pack of the Comparison Service Pack of the Comparison Pack of the Comparison Service Pack of the Comparison Pack o	NGINEERI 195-5658
1.6. NFP/ 1.7. NFP/	72 NATE 101: LIFE	TIONALELECTRIC CODE IONAL FIFE ALARM AND SIGNALING CODE, 2019 TE SAFETY CODE					\$ 3-WAY LIGHT SMITCH		THERMOSTAT		
1.8. NFP/	4 110: STA	ANDARD FOR EMERGENCY AND STANDEY POWER SYSTEMS		X			ELECTRIC	CAL N	OTES	SCALE: AS SHOWN AT AN	SI D
18. NFP4	NAMING NUMBER			x	ISSUE D	ATES	ELECTRIC			SURVEY PREPARED BY:  DESIGN PREPARED BY:	SI D DAT
SHEET NUMBER	NUMBER	DRAWING I	NDE	x	ISSUE D	ATES	IGHTING NOTES:			SURVEY PREPARED BY: 	si D 
- SHEET NUMBER	DRAWING NUMBER	DRAWING II	ISSUED FOR PERMIT 00-13.2024	X	ISSUE D	ATES	IGHTING NOTES:			SURVEY PREPARED BY: — — DESIGN PREPARED BY: — — — — — — — — — — — — — — — — — — —	SI D DK -
2 SHEET NUMBER	DRAWING NUMBER	DRAWING II DRAWING TITLE ELECTRICAL COVER PAGE	NDE PERMIT 00.13.2004	x		ATES	IGHTING NOTES:			SURVEY PREPARED BY: — — DESIGN PREPARED BY: — — — — — — — — — — — — — — — — — — —	SI D SI D - DA
2 3	E DRAWING NUMBER	DRAWING TITLE ELECTRICAL COVER PAGE EXISTING POWER SUPPLY	NDE BERMIT DOL 13 2024	X	ISSUE D	ATES	IGHTING NOTES:			SURVEY PREPARED BY: — DESIGN PREPARED BY: CHECKED BY: — DRAMING PREPARED BY:	SI D DA DA DA DA DA DA
8HEET NUMBER	B-000 E-002	DRAWING TITLE ELECTRICAL COVER PAGE EXISTING POWER SUPPLY EXISTING ELECTRICAL ROOM LAYOUT	NDE Issuepros	X	ISSUE D	ATES	IGHTING NOTES:			SURVEY PREPARED EY: — — DESIGN PREPARED EY: — — — — — — — — — — — — — — — — — — —	
SHEET NUMBER	E-002 E-003	DRAWING TILE DRAWING TILE ELECTRICAL COVER PAGE EXISTING POWER SUPPLY EXISTING ELECTRICAL ROOM LAYOUT PROPOSED ELECTRICAL ROOM LAYOUT	NDE Issuepros	x	ISSUE D	ATES	IGHTING NOTES:			SURVEY PREPARED BY:  DESIGN PREPARED BY: CHECKED BY: JAMAR DILL CHECKED BY:  APPROVED BY: JAMAR DILL PROJECT NUMBER:	SI D DA DA DA DA DA
BHEET NUMBER	2000 E-000 E-000 E-000 E-000	DRAWING TILE DRAWING TILE ELECTRICAL COVER PAGE EXISTING POWER SUPPLY EXISTING ELECTRICAL ROOM LAYOUT PROPOSED ELECTRICAL ROOM LAYOUT REPLECTED CEILING PLAN (LIGHTING, FAN, POWER)		X		ATES	IGHTING NOTES:			SURVEY PREPARED BY:  DESIGN PREPARED BY:  DRAWING PREPARED BY:  CHECKED BY:   APPROVED BY: 	SI D DM DA DA DA DA DA DA DA DA DA DA DA DA DA
BHEET NUMBER	2000 E-000 E-000 E-000 E-000	DRAWING TILE DRAWING TILE ELECTRICAL COVER PAGE EXISTING POWER SUPPLY EXISTING ELECTRICAL ROOM LAYOUT PROPOSED ELECTRICAL ROOM LAYOUT REPLECTED CEILING PLAN (LIGHTING, FAN, POWER)				ATES	IGHTING NOTES:			SURVEY PREPARED BY:  DESIGN PREPARED BY: CHECKED BY: JAMAR DILL CHECKED BY:  APPROVED BY: JAMAR DILL PROJECT NUMBER: OG010030	
2 1 2 2 1 SHEET NUMBER	2000 E-000 E-000 E-000 E-000	DRAWING TILE DRAWING TILE ELECTRICAL COVER PAGE EXISTING POWER SUPPLY EXISTING ELECTRICAL ROOM LAYOUT PROPOSED ELECTRICAL ROOM LAYOUT REPLECTED CEILING PLAN (LIGHTING, FAN, POWER)				ATES	IGHTING NOTES:			SURVEY PREPARED BY:  DESIGN PREPARED BY: CHECKED BY: JAMAR DEL CHECKED BY:  APPROVED BY: -	SI D DK DK DK DK DK DK DK DK DK D
BHEET NUMBER	2000 E-000 E-000 E-000 E-000	DRAWING TILE DRAWING TILE ELECTRICAL COVER PAGE EXISTING POWER SUPPLY EXISTING ELECTRICAL ROOM LAYOUT PROPOSED ELECTRICAL ROOM LAYOUT REPLECTED CEILING PLAN (LIGHTING, FAN, POWER)				ATES	IGHTING NOTES:			SURVEY PREPARED BY:  DESCH PREPARED BY: CHECKED BY: JAMAR DEL CHECKED BY:  APPROED BY: JAMAR DEL PROJECT NUMBER: 09010030 PROJECT NUMBER: 09010030 PROJECT NUMBER: 09010030 PROJECT NUMBER: 09010030 PROJECT NUMBER: 09010030 PROJECT NUMBER: 09010030 PROJECT NUMBER: 09010030 PROJECT NUMBER: 09010030	E PROJECT

